From: Amy Gunter

To: Regan Trapp; Kyle Taylor; Liz Hamilton; April Lucas
Subject: Final Plan for The Cottages at West Village
Date: Thursday, February 25, 2021 6:52:14 AM

Attachments: zoning permit.pdf

2021-02-22 Final Plan Application Findings.pdf

Cottages at West Village-PH1-For Approval 2-23-21.pdf

EAST COTTAGES 24X36 Final Plan.pdf

[EXTERNAL SENDER]

I see there is lots of review going on.

Let's add another!

Final Plan review for The Cottages at West Village - 12 residences, 13 lots.

The plan files are large and I've requested smaller formats.

Thanks!


Amy

Amy Gunter

Rogue Planning & Development Services 541-951-4020

www.rogueplanning.com

This communication, including any attachments hereto or links contained herein, is for the sole use of the intended recipient(s) and may contain information that is confidential or legally protected. If you are not the intended recipient, you are hereby notified that any review, disclosure, copying, dissemination, distribution or use of this communication is prohibited. If you have received this communication in error, please notify the sender immediately by return e-mail message and delete the original and all copies of the communication, along with any attachments from your system.

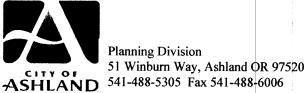

ZONING PERMIT APPLICATION

FILE #_ PA-T1-2021-00142

ITNAL Plan	approval 13 lot 12 unit Perfo	rmance Standards Subdivision, inc.
DESCRIPTION OF PROJECT	approvar 10 lot. 12 differ eno	mance standards subdivision, inc.
DESCRIPTION OF PROPERTY		Pursuing LEED® Certification? ☐ YES ☑ NO
Street Address COFFEE LAN	E	
Assessor's Map No. 39 1E05AD	Tax Lot(s)	200
Zoning R-1-5-P	Comp Plan Designation _	Single Family Residential
<u>APPLICANT</u>		
Name Taylored Elements Construc	tion Phone 541-690-1617 E-Ma	office@tayloredelements.com/kyle@tayloredelements.com
Address <u>1236 Disk Drive</u> , Suite A	City M	edford Zip 97501
PROPERTY OWNER		
Name CMK Development LLC	Phone 541-690-1617 E-Mai	kyle@tayloredelements.com
Address _ 1236 Disk Drive, Suite A	City Me	edford Zip 97501
SURVEYOR, ENGINEER, ARCHITECT, LANDSCA	PE ARCHITECT, OTHER	
Title Engineer Name CEC Engi	neering Phone 541-77	9-5268 _{E-Mail} tony@cecengineering.com
Address PO BOX 1724	City	Medford Zip 97501
_{Title} Landscape Design _{Name} Kerry Ken	cairn Phone 541-48	88-3194 _{E-Mail} kerry@kencairn.com
Address 545 A Street, Suite 3		shland Zip 97520
Planning Consultant: Rogue Planning	& Development Service; 33 N Ce	entral Avenue, Medford OR 97501
true and correct. I understand that all property pins must	be shown on the drawings and visible upon the sponsibility. I further understand that if this require hearing to support this request; ranting of the request; equate; and further	rawings and the required findings of fact, are in all respects, site inspection. In the event the pins are not shown or their lest is subsequently contested, the burden will be on me to
Failure in this regard will result most likely in not only the be removed at my expense. If I have any doubts, I am ad	request being set aside, but also possibly in my vised to seek competent professional advice and 2/2//	y structures being built in reliance thereon being required to dissistance.
Applicant's Signature	Date	-
As owner of the property involved in this request, I howner. Kyle Taylor	ave read and understood the complete app	lication and its consequences to me as a property
Property Owner's Signature (required)	Date	
To be completed by City Staff) Emailed 2.25.2021 Date Received Zoning Pe	ermit Type Type 1 Filing	g Fee <u>\$</u>

The Cottages at West Village Final Plan

The Cottages at West Village Subdivision Final Plan

Property Owner: CMK Properties LLC

1236 Disk Drive, Suite A Medford, OR 97501

Engineer: CEC Engineering

Tony Bakke PO BOX 1724

Medford, OR 97501

Surveyor: L.J. Friar & Associates P.C.

2714 North Pacific Highway

Medford, OR 97501

Site Planning: Kencairn Landscape Architecture

545 A Street, Suite 3 Ashland, OR 97520

Planning Consultant: Rogue Planning & Development Services, LLC

Amy Gunter

1314-B Center Dr., PMB #457

Medford, OR 97501

Subject Property

Map & Tax Lot: 39 1E 050AD; Tax Lot 200 Comprehensive Plan Designation: Single Family Residential

Zoning: R-1-7.5

Adjacent Zones: R-1-5; HC (Healthcare); E-1 and R-3

Overlay Zones: Performance Standards

Wildfire Overlay

Proposal:

The request is for Final Plan approval of Performance Standards Subdivision development of a 12-unit Cottage House Development, The Cottages at West Village, within the larger West Village Subdivision.

Background:

The Cottages at West Village Outline Plan was approved in December 2020 (PA-T2-2020-00021).

The request is for Final Plan review of the previously approved Site Design Review, and Outline Plan review for a 13-lot, 12-unit Performance Standards Subdivision in accordance with Ashland Municipal Code (AMC) 18.2.3.090 and 18.3.9, for a Cottage House Subdivision.

The Cottages at West Village are proposed as 740 square foot, two-bedroom, one bath structures. Each unit is proposed to have a covered entry stoop. The units are proposed with an open floor plan. All units are proposed to include many of the Lifelong Housing Certification features and will works towards Lifelong Housing Certification. All units are proposed to meet Earth Advantage Energy Standards and will be certified as Earth Advantage Silver. The installation of solar panels allows the development to have net metering and will be very low energy usage and their small footprint and drought tolerant landscaping allows for minimal water consumption.

Conditions 1 – 6 from the approval of the Outline Plan have been addressed on the Site Plans, Landscape and Irrigation Plans and Civil Plans. The proposed Civil Plans engineering plan set have been submitted to the Public Works Department for review and approval.

No substantial changes have been made excepting that Otis Street is now named Coffee Lane. Addressing is being assigned by Public Works.

Thank you for your consideration.

On the following pages, findings of fact addressing the criteria from the Ashland Municipal Code are provided. For clarity, the criteria are in Times New Roman font and the applicant's responses are in Calibri font.

FINDINGS OF FACT

PERFORMANCE STANDARDS SUBDIVISION

18.3.9.040.B.5. - Final Plan Approval Criteria

Final Plan approval shall be granted upon finding of substantial conformance with the Outline Plan. This substantial conformance provision is intended solely to facilitate the minor modifications from one planning step to another. Substantial conformance shall exist when a comparison of the outline plan with the final plan meets all of the following criteria.

Finding:

The proposed Final Plan application for The Cottages at West Village, a 12-cottage unit, Performance Standards Subdivision. The site and landscape plans demonstrate substantial conformance with the Outline Plan and Site Design Review. The 37,541 square foot property is zoned single family residential. The density of the property allows 12 cottage units. The proposal Final Plan submittal complies with the standards.

a. The number of dwelling units vary no more than ten percent of those shown on the approved outline plan, but in no case shall the number of units exceed those permitted in the outline plan.

Finding:

The Final Plan for The Cottages at West Village Subdivision proposes 12 single-family residential cottage lots and an open space parcel.

There are no changes in the number of dwelling units.

b. The yard depths and distances between main buildings vary no more than ten percent of those shown on the approved outline plan, but in no case shall these distances be reduced below the minimum established within this Ordinance.

Finding:

No changes to yard depths or distances, between the structures and to the perimeter setbacks have been proposed.

c. The open spaces vary no more than ten percent of that provided on the outline plan.

Finding:

The location and area of the open spaces is the same on the Outline Plan submittals. The lot area requires 7,508.2 square feet of common open space areas. A total of 8,794 square feet of area is provided as common space. This is provided in two areas. The main common open space is on the south side of the site, consisting of two larger lawn areas connected by 20-foot-wide spaces

including pedestrian walkways that link the two lawn areas together. This common area is 7,370 square feet in area. The open spaces provide a common amenity for the residents of The Cottages at West Village Subdivision. The open space will be permanently set aside for the use of the residents.

The common open space area does not have any dimension of less than 20-feet.

The site plan demonstrates that each unit also has 200 square feet of private open space areas, no dimensions of the useable, private open space are less than eight feet in area. There will be a clear delineation of the private open space from the common open space through the installation of fencing that is not more than four feet of solid panel fencing. All common areas and cottage units are connected to and through the development and the common open space with five-foot wide walkways.

d. The building size does not exceed the building size shown on the outline plan by more than ten percent.

Finding:

The building sizes are limited for the cottages lots. There are no changes from the outline plan approval for the locations, sizes, setbacks, or area.

e. The building elevations and exterior materials are in conformance with the purpose and intent of this ordinance and the approved outline plan.

Finding:

The proposed conceptual elevations provided with the Outline Plan Submittals for two types of small cottage units. The proposed residences, at the time of individual building permit, the plans will again demonstrate compliance with the heights, standard setbacks, confirmation of compliance with the solar setback standards.

f. That the additional standards which resulted in the awarding of bonus points in the outline plan approval have been included in the final plan with substantial detail to ensure that the performance level committed to in the outline plan will be achieved.

Finding:

No density bonuses apply to cottage developments. The proposed units will be developed to similar energy standards as the proposed Earth Advantage units proposed in the West Village Subdivision. The solar panels will allow for net metering to achieve limited electrical consumption.

g. The development complies with the Street Standards.

Finding:

The proposed development is accessed via a driveway that extends from the new street, Coffee Lane. This street has been developed to city standards with asphalt travel lanes, curb, gutter, park row and sidewalk.

Cottage housing developments are not required to provide a public street dedication when pedestrian connectivity through the site to adjacent properties is provided and adequate vehicular access is provided. See findings above addressing block length.

h. Nothing in this section shall limit reduction in the number of dwelling units or increased open space provided that, if this is done for one phase, the number of dwelling units shall not be transferred to another phase, nor the open space reduced below that permitted in the outline plan.

Finding:

The proposal is consistent with the layout, dimensions, and the number of units approved thorough Outline Plan approval. The open spaces areas are shown on the Landscape Site Plans and are adequate areas. The proposed density of the property with 12 cottages is the maximum number of cottages house units allowed in the zone per the Cottage Housing Standards of the Ashland Municipal Code AMC 18.2.3.090.

Attachments:

- A) West Village Subdivision Tentative Plat (The Cottages at West Village inset)
- B) The Cottages at West Village Subdivision approved Civil Improvement Plans
- C) The Cottages at West Village Subdivision Landscape and Irrigation Plans
- D) Draft HOA and CC&Rs for West Village Subdivision

GENERAL NOTES

1. ALL WORK SHALL CONFORM TO THE APWA/ODOT STANDARD SPECIFICATIONS FOR PUBLIC WORKS CONSTRUCTION, OREGON CHAPTER, 2018 AND AS AMENDED BY THE CITY OF ASHLAND ENGINEERING DEPARTMENT.

2. STORM DRAIN PIPE SHALL BE AS INDICATED ON THE PROJECT PLANS. ONLY WHITE OR BLACK PIPE IS PERMITTED PER CITY STDS. PRIVATE STORM DRAIN PIPE (4", 6" & 8") SHALL BE PVC CONFORMING TO ASTM D-3034. EACH SERVICE TERMINATION POINT SHALL BE MARKED WITH A PAINTED 2" x 4" AND STORM DRAIN DETECTOR TAPE SHALL BE USED.

3. SANITARY SEWER PIPE SHALL BE PVC (ASTM D-3034). SANITARY SEWER LATERALS SHALL BE CONNECTED TO THE MAIN WITH A ONE PIECE PREFABRICATED SEWER WYE AND SHALL EXTEND 2' BEYOND THE P.U.E. EACH SERVICE TERMINATION POINT SHALL BE MARKED WITH A PAINTED GREEN 2" x 4". SANITARY SEWER DETECTOR TAPE SHALL BE USED. ONLY GREEN PIPE ALLOWED PER CITY STANDARDS.

4. CLASS "B" BACKFILL SHALL BE USED IN ALL TRENCHES WITHIN THE RIGHT OF WAY AND SHALL BE COMPACTED TO 95% MAXIMUM DENSITY (PER CITY OF ASHLAND). CLASS "E" BACKFILL SHALL BE USED IN ALL TRENCHES UNDER ASPHALT.

5. GRANULAR MATERIALS SHALL BE OBTAINED FROM A CITY APPROVED SOURCE. CONTRACTOR SHALL NOTIFY THE CITY ENGINEER OF THE MATERIAL SOURCE PRIOR TO ANY GRANULAR MATERIAL PLACEMENT. CONTRACTOR SHALL NOT CHANGE MATERIAL SOURCE WITHOUT PRIOR APPROVAL FROM THE CITY ENGINEER.

6. ALL STORM DRAIN CURB INLETS SHALL BE CITY OF ASHLAND TYPE 4A WITH A 4' CURB OPENING UNLESS OTHERWISE SPECIFIED ON THE PLANS.

7. ALL STORM DRAIN PIPES SHALL HAVE WATER-TIGHT JOINTS. PVC AND POLYPROPYLENE PIPE JOINTS SHALL CONFORM TO ASTM D-3212 (TESTABLE JOINTS). PRE-MANUFACTURED TEES SHALL BE USED FOR LATERALS CONNECTING TO NEW STORM DRAIN/SANITARY SEWER

8. ALL WATER PIPE SHALL BE PER CURRENT CITY OF ASHLAND STANDARDS, BE FULLY RESTRAINED AND VISIBLY RECOGNIZABLE AS SUCH (EBAA MEGALUG OR APPROVED EQUAL). a. PIPE: AWWA 21.51 DUCTILE IRON, CLASS 54, FULLY RESTRAINED JOINT UNLESS

- b. FITTINGS: AWWA C116 OR C153 WITH "EBAA MEGALUGS" OR APPROVED EQUAL. ALL VALVES, FITTINGS, ETC. TO BE DOMESTIC. RESTRAIN ALL JOINTS UNLESS OTHERWISE NOTED ON PLANS.
- c. THRUST BLOCKS: AT ALL ELBOWS AND TEES, ETC. d. THE CITY SHALL INSTALL ALL WATER SERVICES INCLUDING THE TAP, SERVICE
- LINE & METER. THE CONTRACTOR SHALL INSTALL THE METER BOX, LID & e. THE OWNER SHALL ENTER INTO AN AGREEMENT WITH THE CITY TO STERILIZE ALL WATER SERVICES. COSTS FOR THIS WORK WILL BE BILLED BY THE CITY TO THE
- f. CITY OF ASHLAND WATER DEPARTMENT FORCES WILL PREFORM PRESSURE TEST

OWNER ON AN ACTUAL COST BASIS FOR LABOR, MATERIALS, EQUIPMENT RENTAL

- OF WATER SYSTEM g. ALL FIRE HYDRANTS SHALL BE KENNEDY K81-D.
- h. CONTRACTOR SHALL FURNISH ENGINEER OF RECORD AND CITY WITH DATA ON ALL VALVES AND PIPE APPURTENANCES WITH THE AS-BUILTS.

9. SEPARATION OF SANITARY SEWER AND WATER MAINS SHALL BE IN ACCORDANCE WITH OREGON STATE HEALTH DIVISION RULES AND/OR AS MODIFIED BY THE CITY OF ASHLAND.

10. ALL GIVEN PIPE LENGTHS AND SLOPES ARE FROM CENTER OF STRUCTURE TO CENTER OF STRUCTURE.

11. ALL WORK ON GRAVITY STORM DRAIN AND SANITARY SEWER SYSTEMS SHALL BEGIN AT THE LOWEST POINT AND PROCEED UPGRADE TO THE HIGHEST POINT. WORK SHALL NOT BEGIN ANYWHERE OTHER THAN THE LOWEST POINT. DO NOT LEAVE OUT SECTIONS OF THE SYSTEM AND RESTART AT A HIGHER POINT. CAP/PLUG SS DAILY DURING CONSTRUCTION.

12. THE LOCATION AND ELEVATION OF ALL EXISTING UTILITIES AND STRUCTURES ARE APPROXIMATE. THERE MAY EXIST UTILITIES THAT ARE NOT SHOWN ON THE PLANS. THE CONTRACTOR IS RESPONSIBLE FOR LOCATING ALL UTILITIES PRIOR TO CONSTRUCTION.

13. CONTRACTORS AND SUBCONTRACTORS SHALL BE PREQUALIFIED WITH THE CITY OF ASHLAND ENGINEERING DEPARTMENT PRIOR TO STARTING WORK. CONTRACTOR SHALL NOTIFY OREGON UTILITY NOTIFICATION CENTER (1-800-332-2344) AND THE CITY OF ASHLAND ENGINEERING (541-488-5347) 48 HOURS PRIOR TO STARTING WORK.

14. CONTRACTOR SHALL BE RESPONSIBLE FOR COORDINATION WITH THE VARIOUS UTILITY COMPANIES REGARDING INSTALLATION AND/OR RELOCATION REQUIREMENTS FOR THEIR


15. CONTRACTOR IS RESPONSIBLE FOR OBTAINING ALL REQUIRED PERMITS PRIOR TO CONSTRUCTION.

- 16. STABILIZATION FABRIC SHALL CONFORM TO ODOT 2018 SPECIAL PROVISIONS 02320. 17. POWER FACILITIES SHOWN ON THESE PLANS ARE FOR REFERENCE ONLY. SEE POWER PLANS PREPARED BY CITY OF ASHLAND ELECTRIC DEPARTMENT FOR DETAILED PLANS & SPECIFICATIONS.
- 18. BASIS OF BEARING: SEE TOPOGRAPHIC SURVEY, SHEET T.1
- 19. BENCHMARK: SEE TOPOGRAPHIC SURVEY, SHEET T.1

CIVIL IMPROVEMENT PLANS

THE COTTAGES AT WEST VILLAGE PHASE I

LOCATED IN SECTION 5, T. 39 S., R. I E., W.M. TAX LOT 200 CITY OF ASHLAND JACKSON COUNTY, OREGON

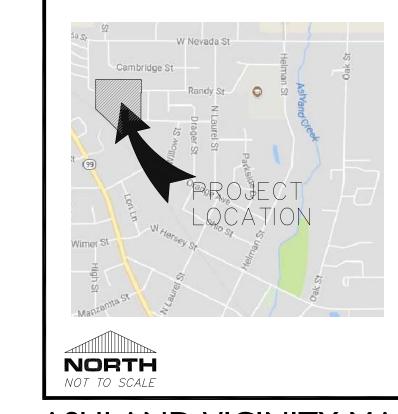




ABBREVIATIONS

- B/W = BACK OF WALKC.I. = CURB INLETCR = CURB RETURNFG = FINISH GRADE
- GB = GRADE BREAK G.I. = GUTTER INLET - RD364 PC - POINT OF CURVE PRC = POINT OF REVERSE CURVE
- PT = POINT OF TANGENTPV = PAVEMENTR/W = RIGHT - OF - WAY
- SD = STORM DRAINSDMH = STORM DRAIN MANHOLE
- S.I. = STREET INTERSECTIONSS = SANITARY SEWERSS C.O. = SANITARY SEWER CLEANOUT
- SSMH = SANITARY SEWER MANHOLE TC = TOP OF CURB


VC = VERTICAL CURVEW = WATER

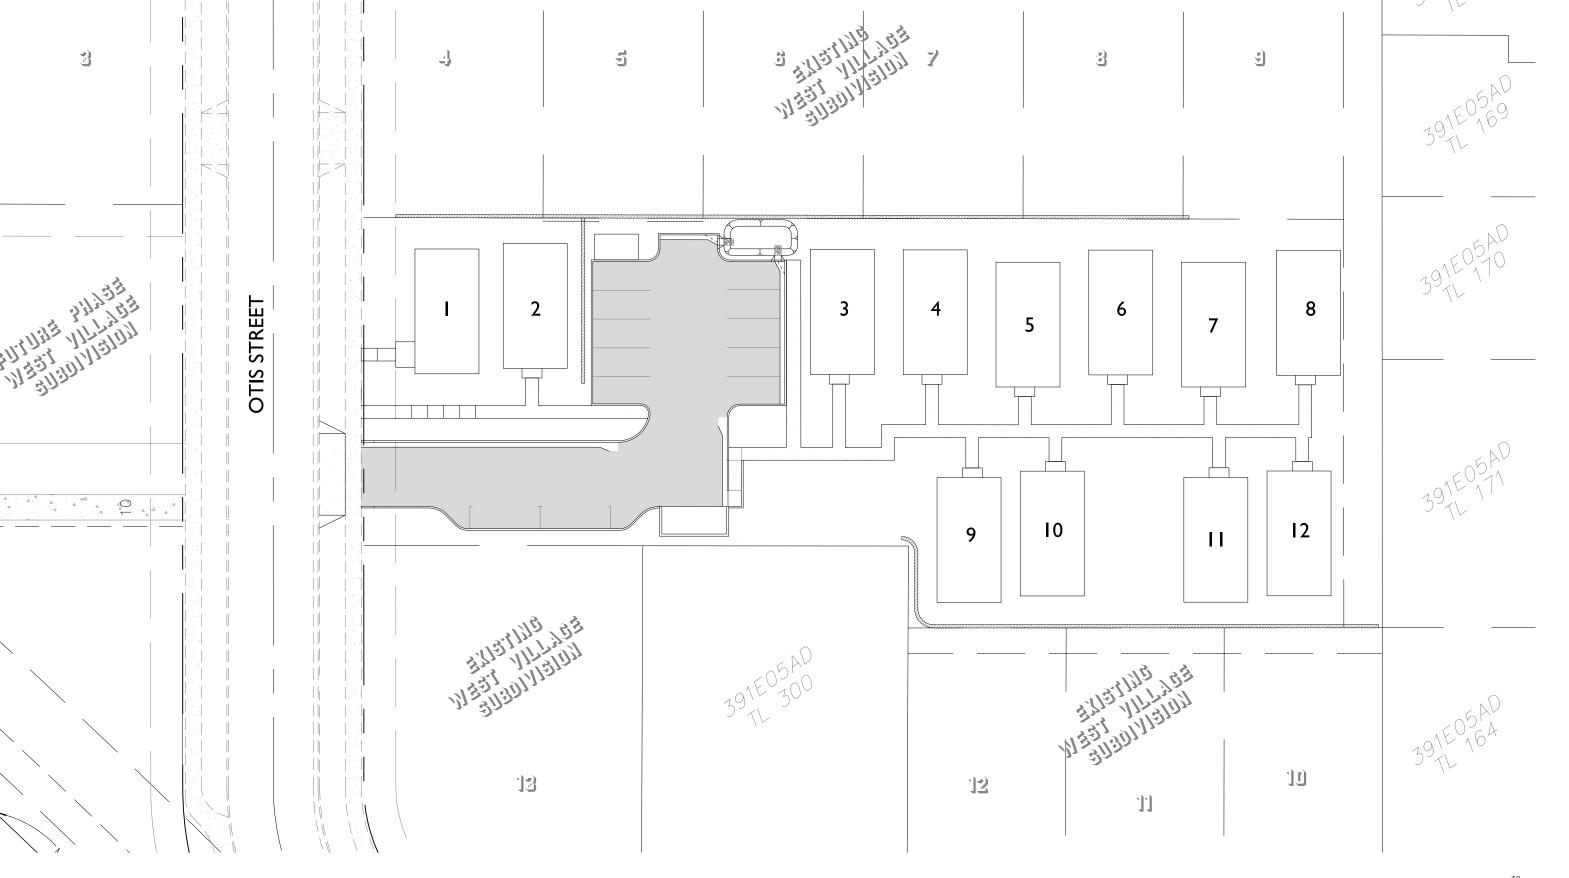


SITE INDEX MAP

TREE PROTECTION NOTE


THE CONTRACTOR IS RESPONSIBLE TO OBTAIN A COPY OF THE TREE PROTECTION PLAN PREPARED BY THE PROJECT LANDSCAPE ARCHITECT. ALL TREE PROTECTION MEASURES SHALL BE IN PLACE PRIOR TO THE START OF ANY CONSTRUCTION ACTIVITIES. A PRE-CONSTRUCTION MEETING WITH THE LANDSCAPE ARCHITECT IS REQUIRED PRIOR TO CONSTRUCTION.

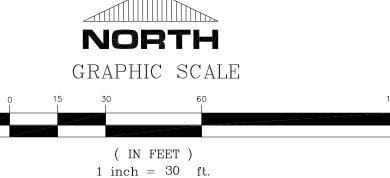

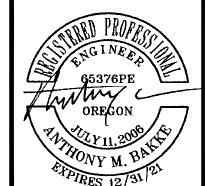



Call before you dig.


CONTACT INFOR	MATION	LEGEND		SHEET INDEX	NO. REVISION	DATE B
ENGINEER OF RECORD: TONY BAKKE, P.E. C.E.C. ENGINEERING, INC. 132 W. MAIN ST., SUITE 103 MEDFORD, OR 97501 (541) 779-5268 SURVEYOR OF RECORD: JAMES HIBBS, PLS L.J. FRIAR & ASSOCIATES 2714 N. PACIFIC HWY MEDFORD, OR 97501 (541) 772-2782 CELECTRIC/AFN: DAVE TYGERSON CITY OF ASHLAND 90 NORTH MOUNTAIN ASHLAND, OR 97520 (541) 552-2389 DEVELOPER/OWNER: KYLE TAYLOR PDK PROPERTIES, LLC 588 PARSONS DRIVE MEDFORD, OR 97501 (541) 690-1617 CITY/ASHLAND PUBL KARL JOHNSON ENGINEERING DIVISION 51 WINBURN WAY ASHLAND, OR 97520 (541) 552-2415 IRRIGATION: SHAVON HAYNES OREGON WATER RES 10 S. OAKDALE AVE. MEDFORD, OR 97501 (541) 690-1617 (541) 774-6883	CHARTER COMMUNICATIONS ERIC CHASE 1341 CENTER DR., SUITE C MEDFORD, OR 97501 (541) 500-8992 GAS COMPANY: ERIK ENRIQUEZ AVISTA UTILITIES 580 BUSINESS PARK DR MEDFORD, OR 97504 (458) 225-4732 TELEPHONE COMPANY: CAMERON DIBETTA	LINES ### PROPOSED PVMNT	CLEAN-OUT SERVICE WYE WATER SERVICE WATER SERVICE CATCH/LYNCH BASIN FIRE HYDRANT WATER VALVE STREET LIGHT FITTING &, T.B. DRAINAGE FLOW AIR VALVE POWER TRANSFORMER POWER SWITCHGEAR CURB INJET	COVER SHEET ROADWAY SECTIONS & SPECIAL DETAILS SITE / UTILITY PLAN B. I-B. 2 PRIVATE DRIVE PLAN & PROFILE C. I GRADING PLAN D. I-D. GRADING SECTIONS EROSION & SEDIMENT CONTROL PLAN E. I-E. 2 DETAIL SHEETS TOPOGRAPHIC SURVEY T. I	CITY OF ASHLAND	PROJECT NO DRAWING N A. 1

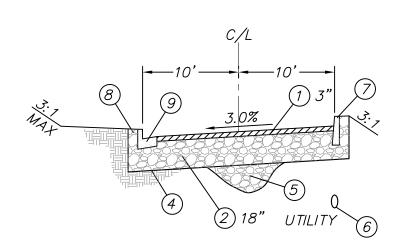


TYPICAL SECTION PRIVATE DRIVE (STA:45+27.50 TO 45+48.32)

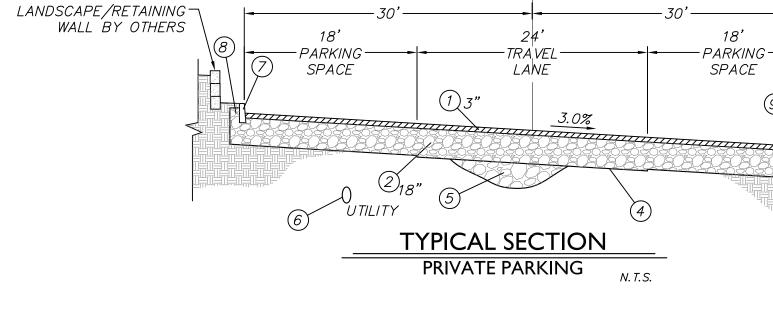

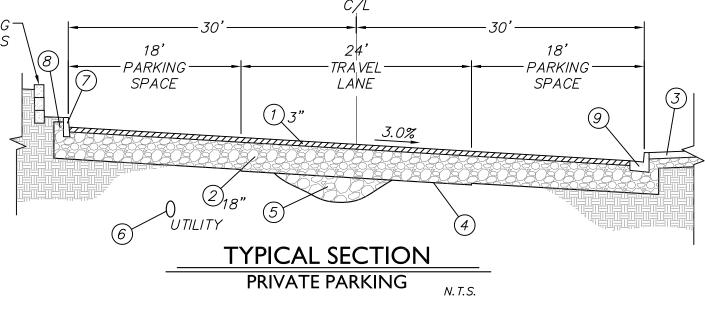


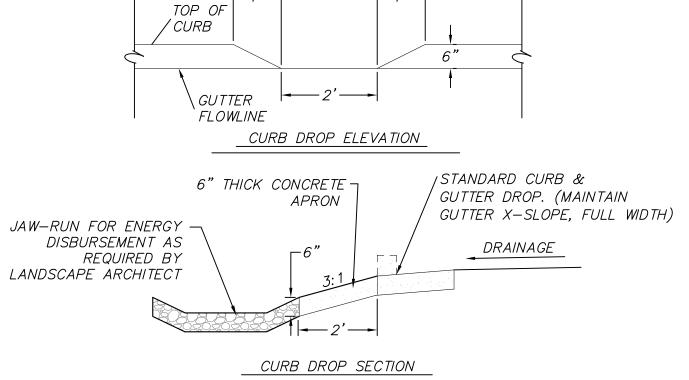

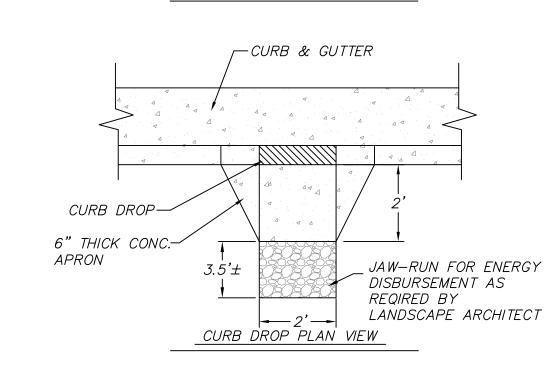

CURB DROP DETAIL


N. T. S.

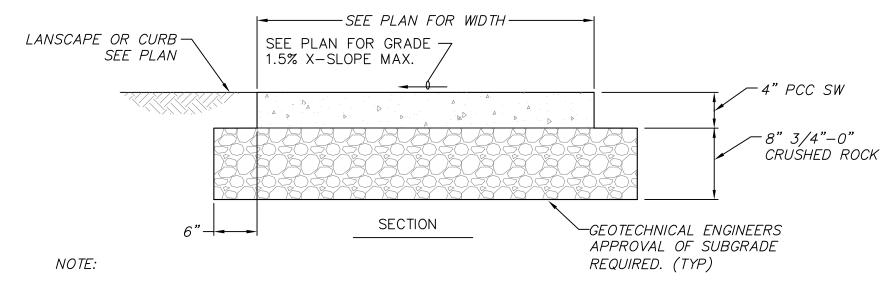


- 1. EXPOSED SURFACES TO BE MEDIUM BROOM FINISHED
- 2. CONCRETE SHALL BE CLASS 3000 COMMERCIAL GRADE CONCRETE WITH CONTRACTION JOINTS AT 5'-0" O.C., EXPANSION JOINTS AT 50'-0" O.C.
- 3. IN EMBANKMENT AREAS IMPORTED SUBBASE TO BE 4"-0" CRUSHED ROCK.
- 4. WHERE ADJACENT TO CURB, ALIGN SIDEWALK AND CURB JOINTS, PROVIDE V-GROOVE JOINT BETWEEN BACK OF CURB AND FACE OF S/W.
- 5. CONTRACTOR TO CONFIRM ALL SIDEWALK AND RAMPS ARE COMPLIANT WITH ADA ACCESSIBILITY REQUIREMENTS.

PRIVATE SIDEWALK N. T. S. TYPICAL SECTION



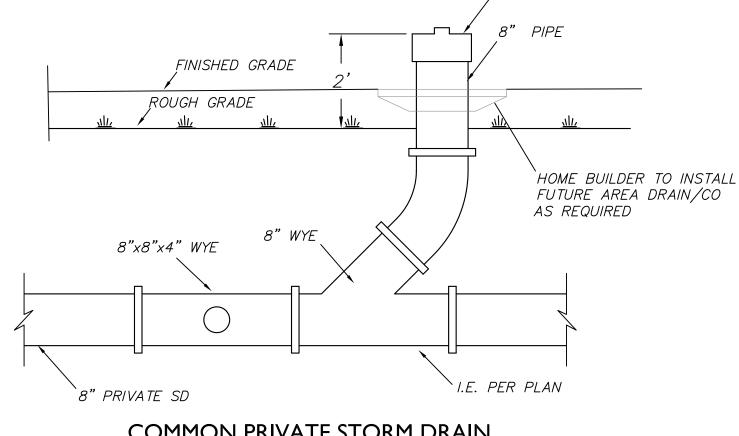

COMMON PRIVATE STORM DRAIN AREA DRAIN AND WYE DETAIL

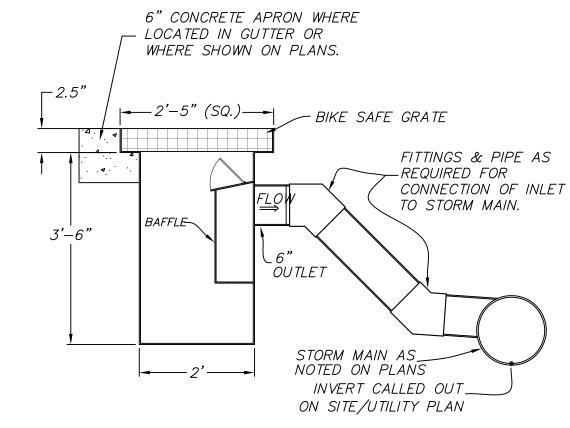

STEEL LYNCH BASIN DETAIL NOT TO SCALE

(PRIVATE) NOTE: MODEL CB-42HB AS MANUFACTURED BY GRATEMASTER, INC. HILLSBORO, OR

GEOTECHNICAL NOTES

NOTE: PAVEMENT SECTIONS ARE BASED UPON GEOTECHNICAL RECOMMENDATIONS BY APPLIED GEOTECHNICAL ENGINEERING AND GEOLOGIC CONSULTING LLC. CONTRACTOR SHALL COORDINATE WITH GEOTECHNICAL ENGINEER DURING CONSTRUCTION FOR CONFORMANCE WITH REQUIREMENTS.

NOTE: THE CONTRACTOR SHALL OBTAIN A COPY OF THE GEOTECH REPORT PREPARED BY: APPLIED GEOTECHNICAL ENGINEERING AND GEOLOGIC CONSULTING LLC AND COMPLY WITH THE RECOMMENDATIONS CONTAINED IN THE REPORT.

NOTE: THE PAVEMENT SECTIONS SHOWN ARE BASED ON THE ASSUMPTION THAT PAVEMENT CONSTRUCTION WILL BE ACCOMPLISHED DURING THE DRY SEASON. IF WET-WEATHER PAVEMENT CONSTRUCTION IS CONSIDERED, IT WILL LIKELY BE NECESSARY TO INCREASE THE THICKNESS OF THE CRUSHED ROCK BASE TO SUPPORT CONSTRUCTION EQUIPMENT AND PROTECT THE MOISTURE-SENSITIVE SUBGRADE SOILS FROM DISTURBANCE. IT SHOULD BE NOTED THAT THE PAVEMENT SECTIONS MAY NOT BE ADEQUATE FOR THE SUPPORT OF INTENSE, HEAVY CONSTRUCTION TRAFFIC.

GEOTECHNICAL PRE-CONSTRUCTION & SUBGRADE APPROVAL


NOTE: CONTRACTOR IS TO HOLD A PRE-CONSTRUCTION MEETING WITH CITY DESIGNATED INSPECTOR PRIOR TO THE START OF CONSTRUCTION.

NOTE: PROJECT GEOTECHNICAL ENGINEER OR QUALIFIED EXPERIENCED CITY INSPECTOR MUST PROVIDE APPROVAL OF THE SUBGRADE PRIOR TO PLACEMENT OF ROADWAY ROCK SECTION AND/OR GEOTEXTILE FABRIC. INSPECTOR SHALL PROVIDE WRITTEN CONFIRMATION TO THE ENGINEER OF RECORD AND THE CITY PUBLIC WORKS DEPARTMENT WITHIN 10 WORKING DAYS.

TYPICAL SECTION CONSTRUCTION NOTES


- (1) LEVEL 2, 1/2" DENSE HMAC (DEPTH AS NOTED).
- (2) 3/4"-MINUS CRUSHED ROCK (DEPTH AS NOTED).
- 3 SIDEWALK ADJACENT TO CURB PER CURRENT OREGON STANDARD DRAWING RD720. AGGREGATE BASE DEPTH SHALL MATCH ADJACENT ROADWAY SECTION AND EXTEND 12" BEYOND EDGE OF SIDEWALK.
- GEOTEXTILE STABILIZATION FABRIC PER 2018 OREGON STANDARD SPECIFICATION, SPECIAL PROVISION 02320 (SUBGRADE GEOTEXTILE).
- (5) IMPORTED SUBBASE (WHERE APPLICABLE) TO BE 4"-0" CRUSHED ROCK.
- 6 CONTRACTOR TO MOUND OVER UNDERGROUND UTILITIES WITH 3/4"-MINUS GRAVEL FOLLOWING UTILITY INSTALLATION TO MAINTAIN 18" MINIMUM COVER AT ALL TIMES.
- (7) 16" STANDARD CURB (E=6") PER CURRENT OREGON STANDARD DRAWING RD700.
- (8) BASE MATERIAL TO EXTEND 12" BEHIND CURB (TYPICAL).
- (9) 24" CURB & GUTTER (E=6") PER CURRENT OREGON STANDARD DRAWING RD700.
- NOTE: CROSS SECTIONS ARE ALWAYS VIEWED LOOKING "UP-STATION".

NOTE: AC PAVING & CRUSHED ROCK SECTION DEPTHS NOTED ARE FOR DRY WEATHER CONSTRUCTION ONLY. WET WEATHER CONSTRUCTION WILL REQUIRE AN INCREASED SECTION DEPTH AS DETERMINED IN THE FIELD BY THE PROJECT GEOTECHNICAL ENGINEER. THE CONTRACTOR IS REQUIRED TO CONTACT THE PROJECT GEOTECHNICAL ENGINEER FOR APPROVAL OF SUBGRADE PRIOR TO THE PLACEMENT OF ANY CRUSHED ROCK.

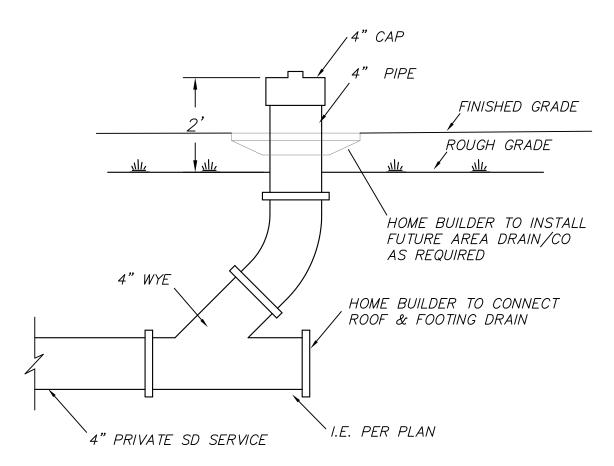


INDIVIDUAL PRIVATE STORM SERVICE AREA DRAIN AND WYE DETAIL

NTS

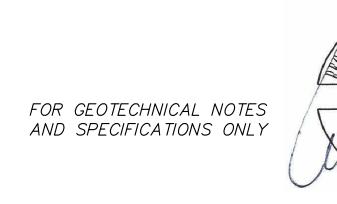



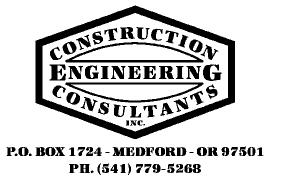

DRAWN BY: BRO	DATE:	10/19	
CHECKED BY: AMB	DATE:	10/19	
APPROVED RVS:	DATE:		
APPROVED:	DATE:		
APPROVED:	DATE:		
APPROVED:	DATE:		
			1

				1	
	NO.	REVISION	DATE	BY	
•					
i					/
					Ľ
					#
					\ \


THE PROPERTY
65376PE
OREGON
THONY M. BALLS


CONSTRUCTION ENGINEERING CONSU	LTANTS
THE COTTAGES AT WEST VILLAGE	PROJECT NO.


THE COTTAGES AT MEST MILLAGE PHASES I CIVIL IMPROVEMENTS CROSS SECTIONS AND SPECIAL DETAILS DRAWING NO.


NAME: A.2-WES-ECOT-XSECS.dwg PROJ.: 20-56 PLOT DATE: 2/5/21


A.2

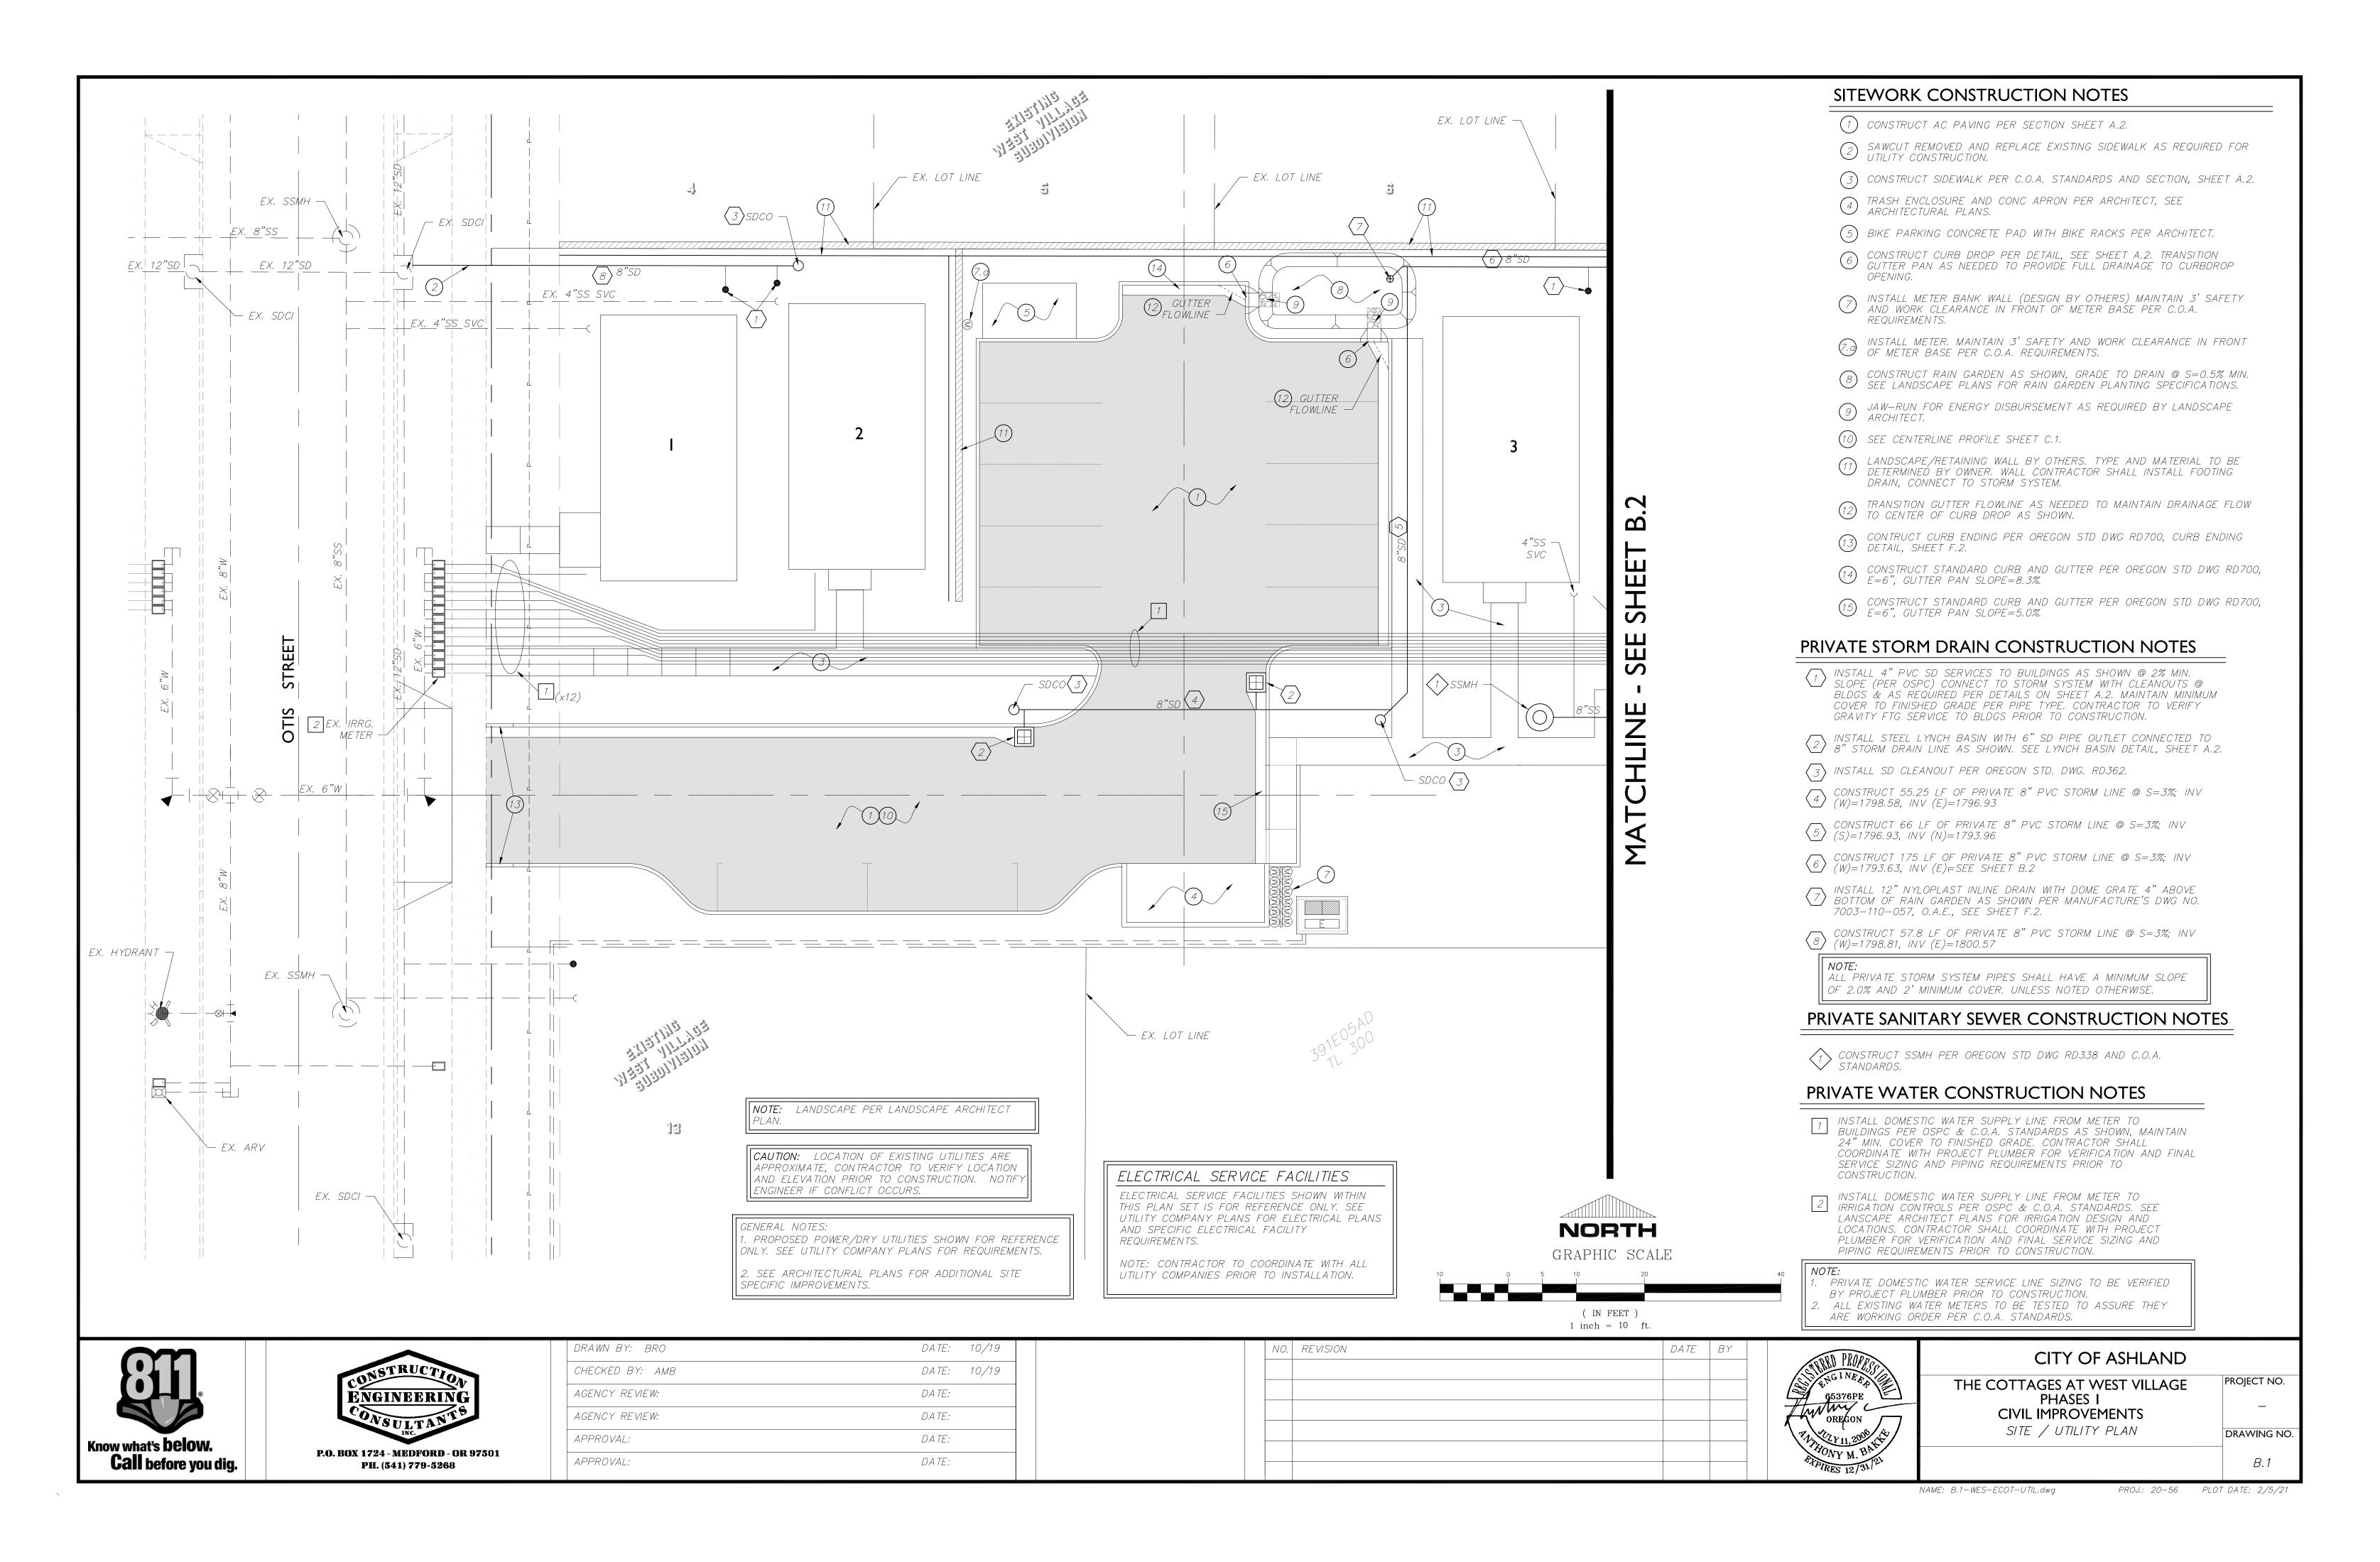


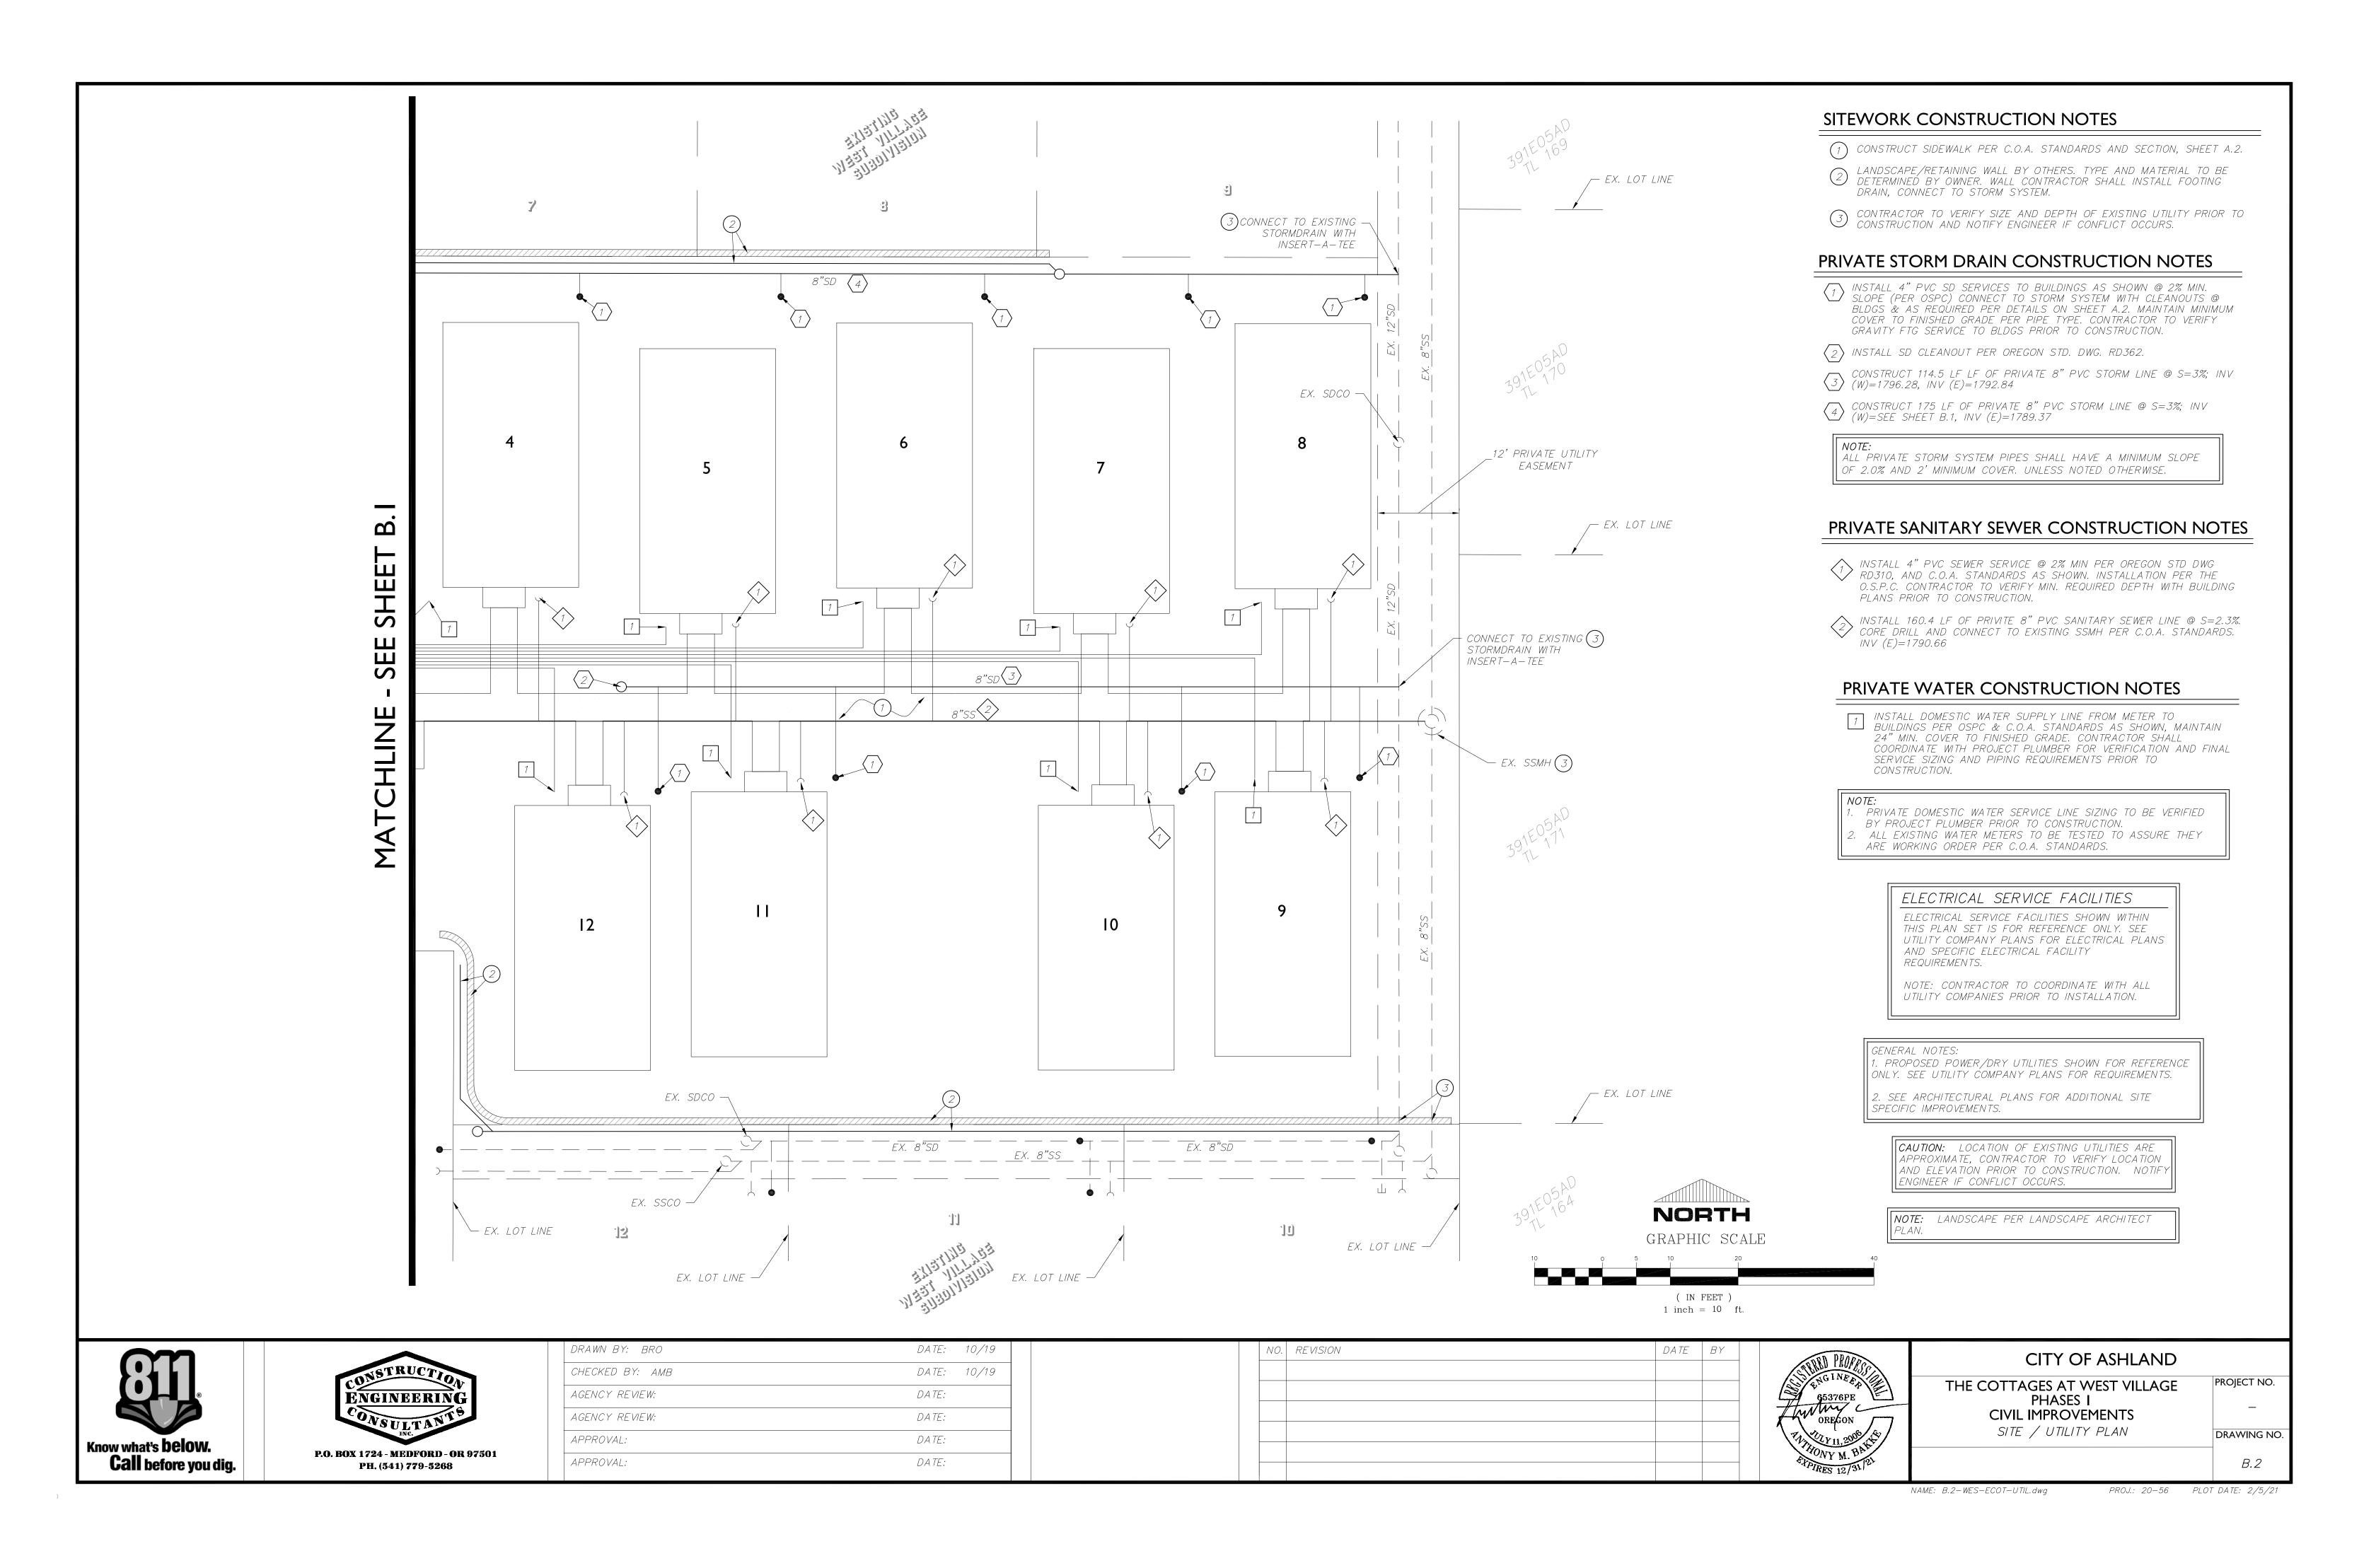

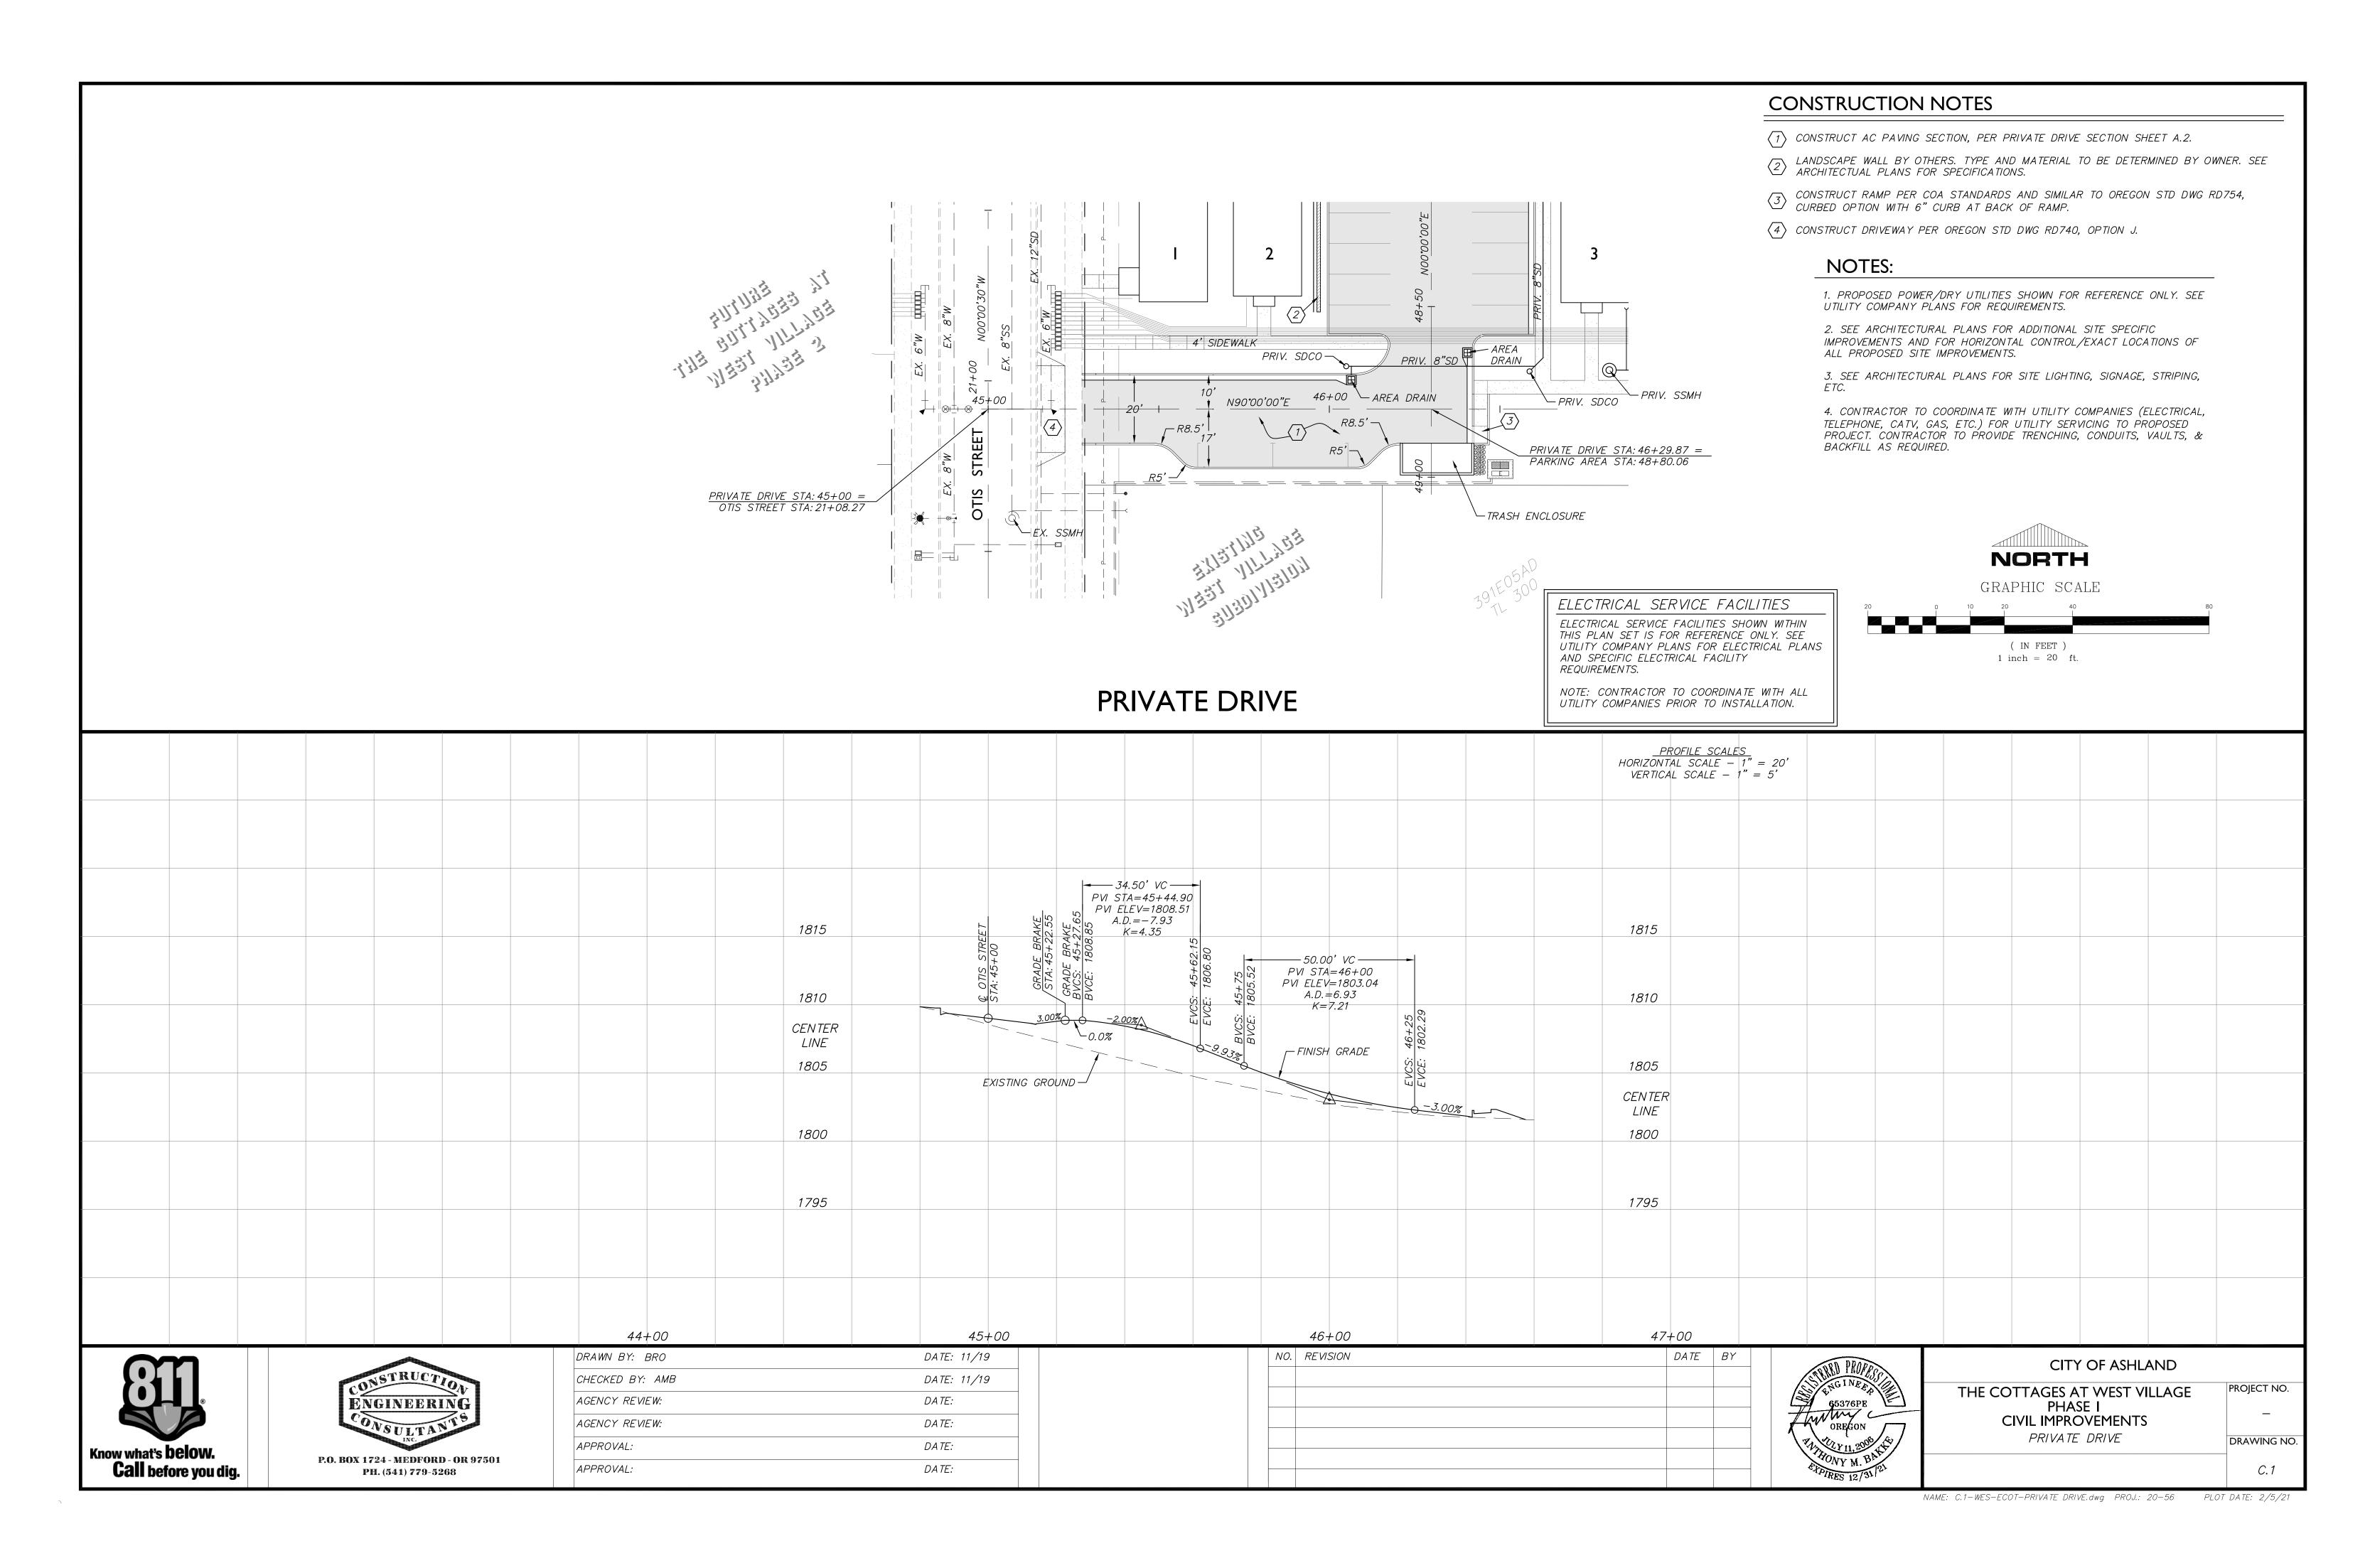

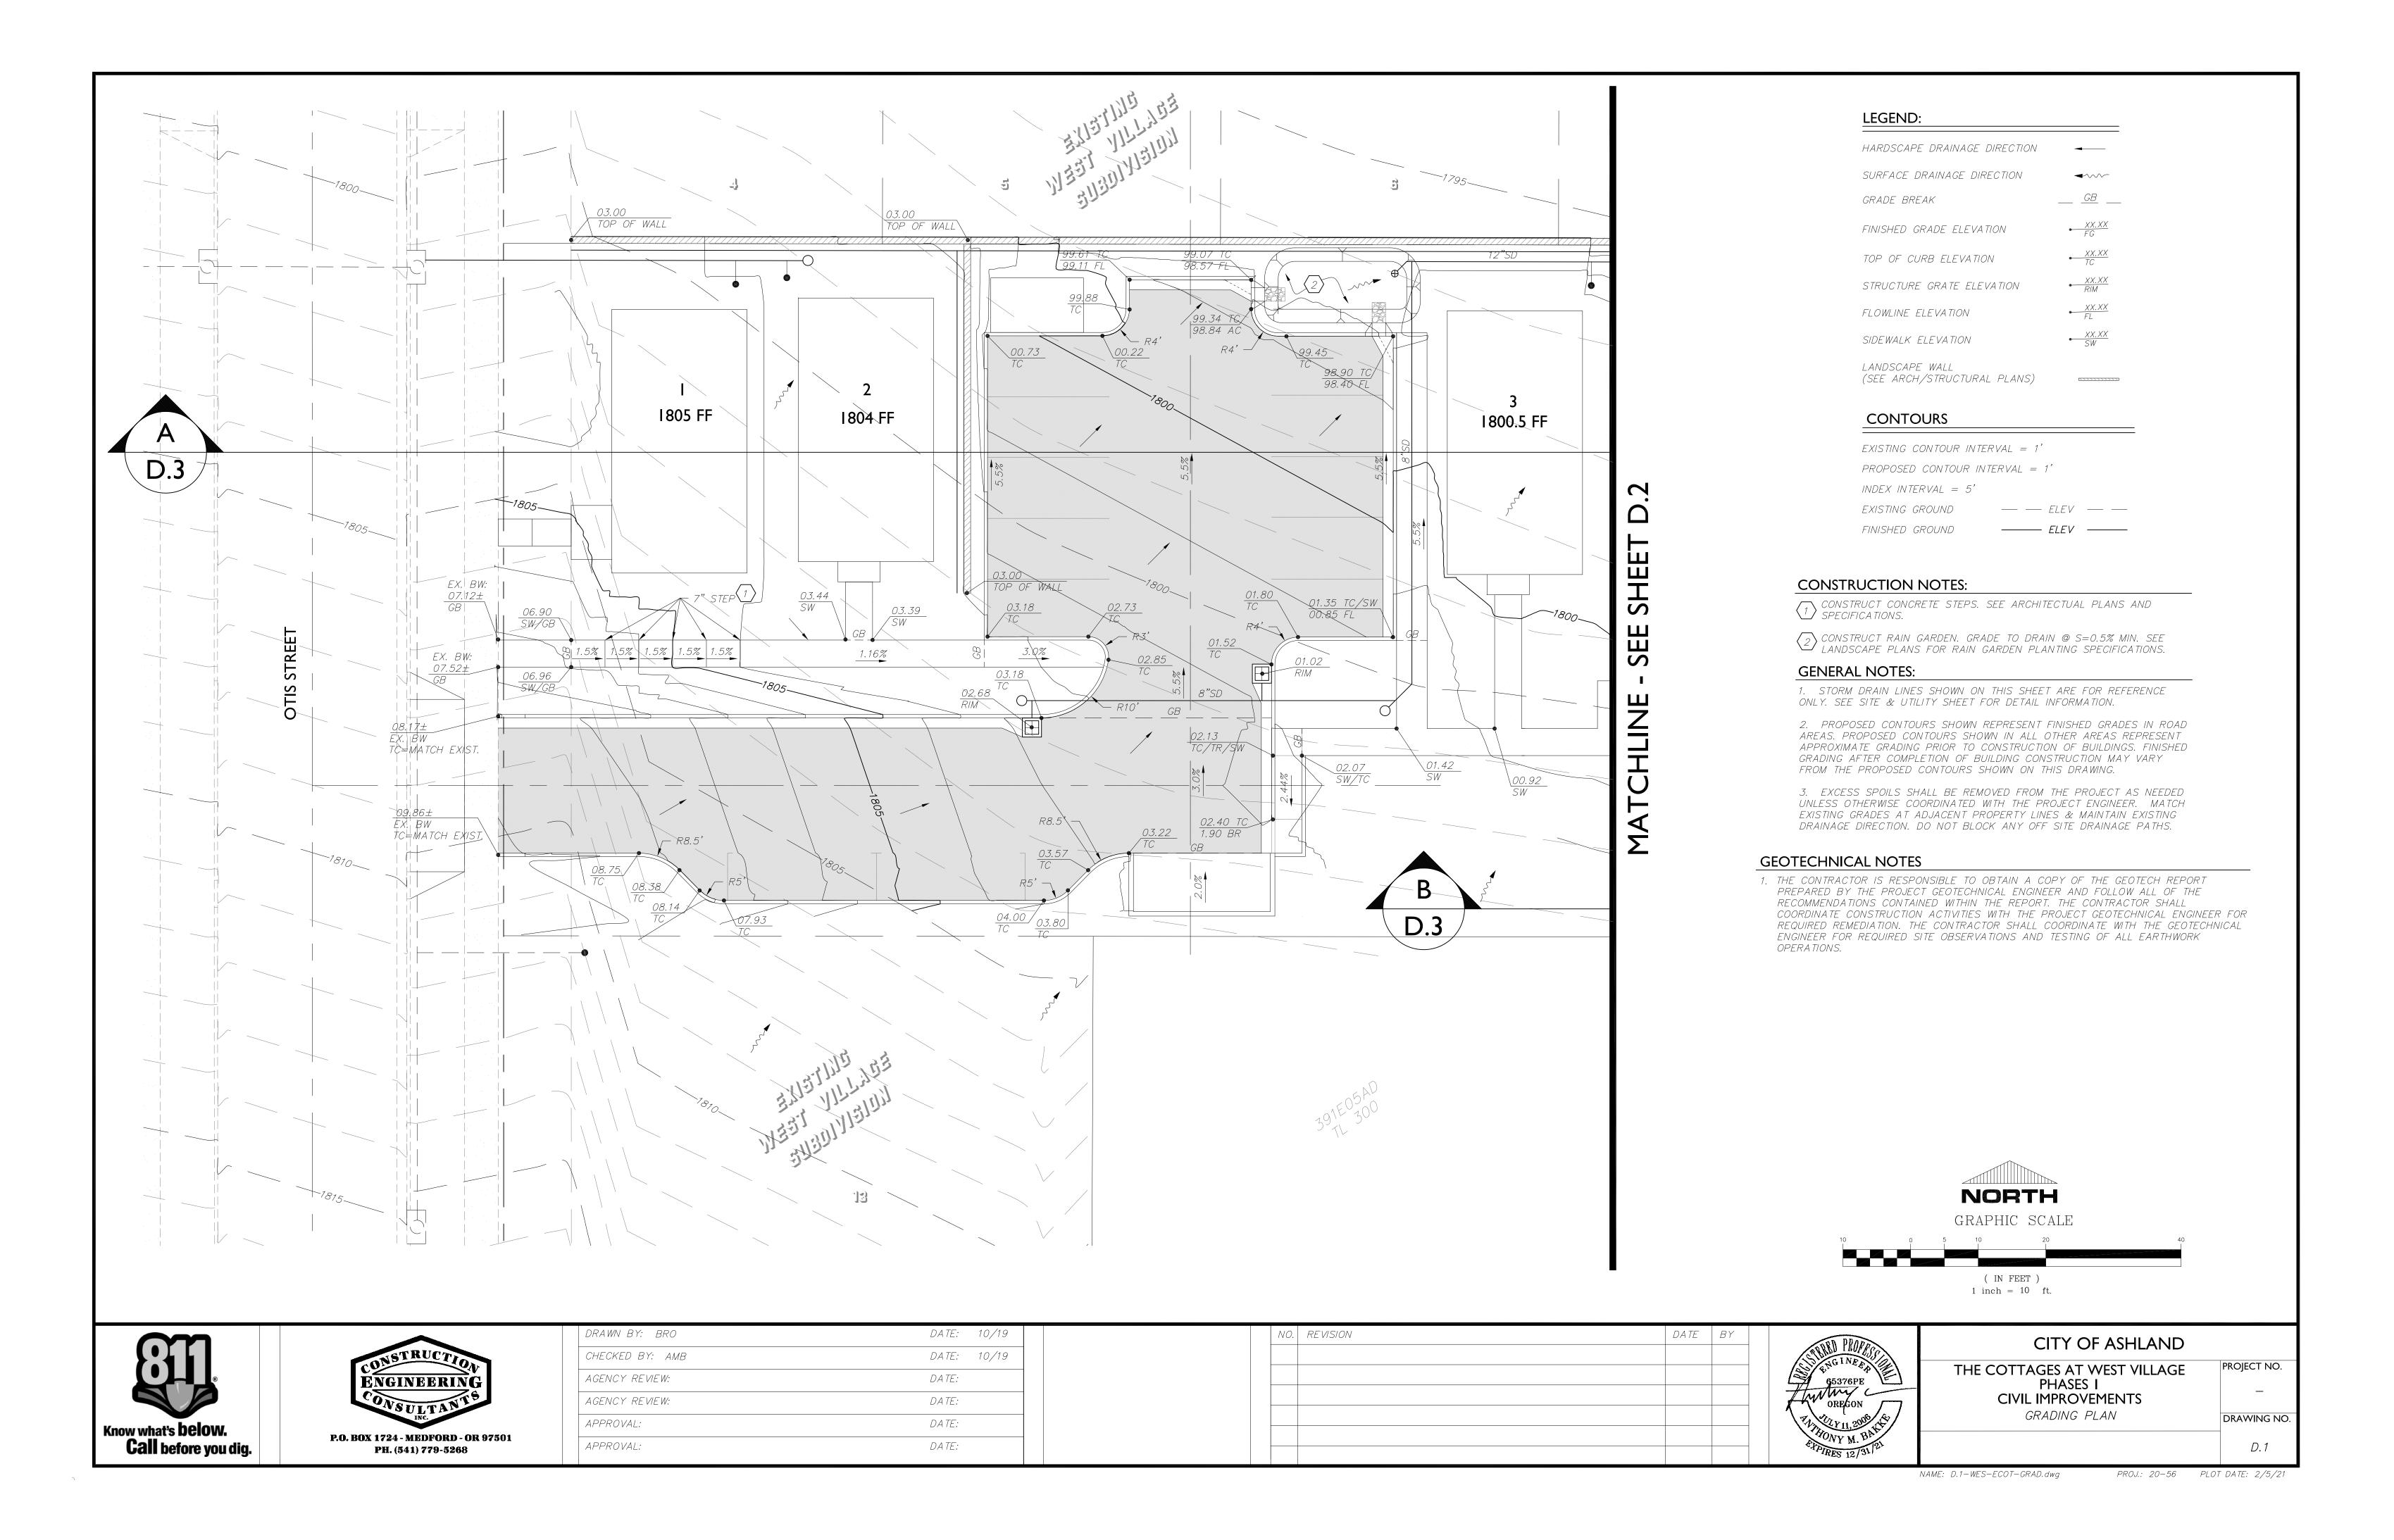

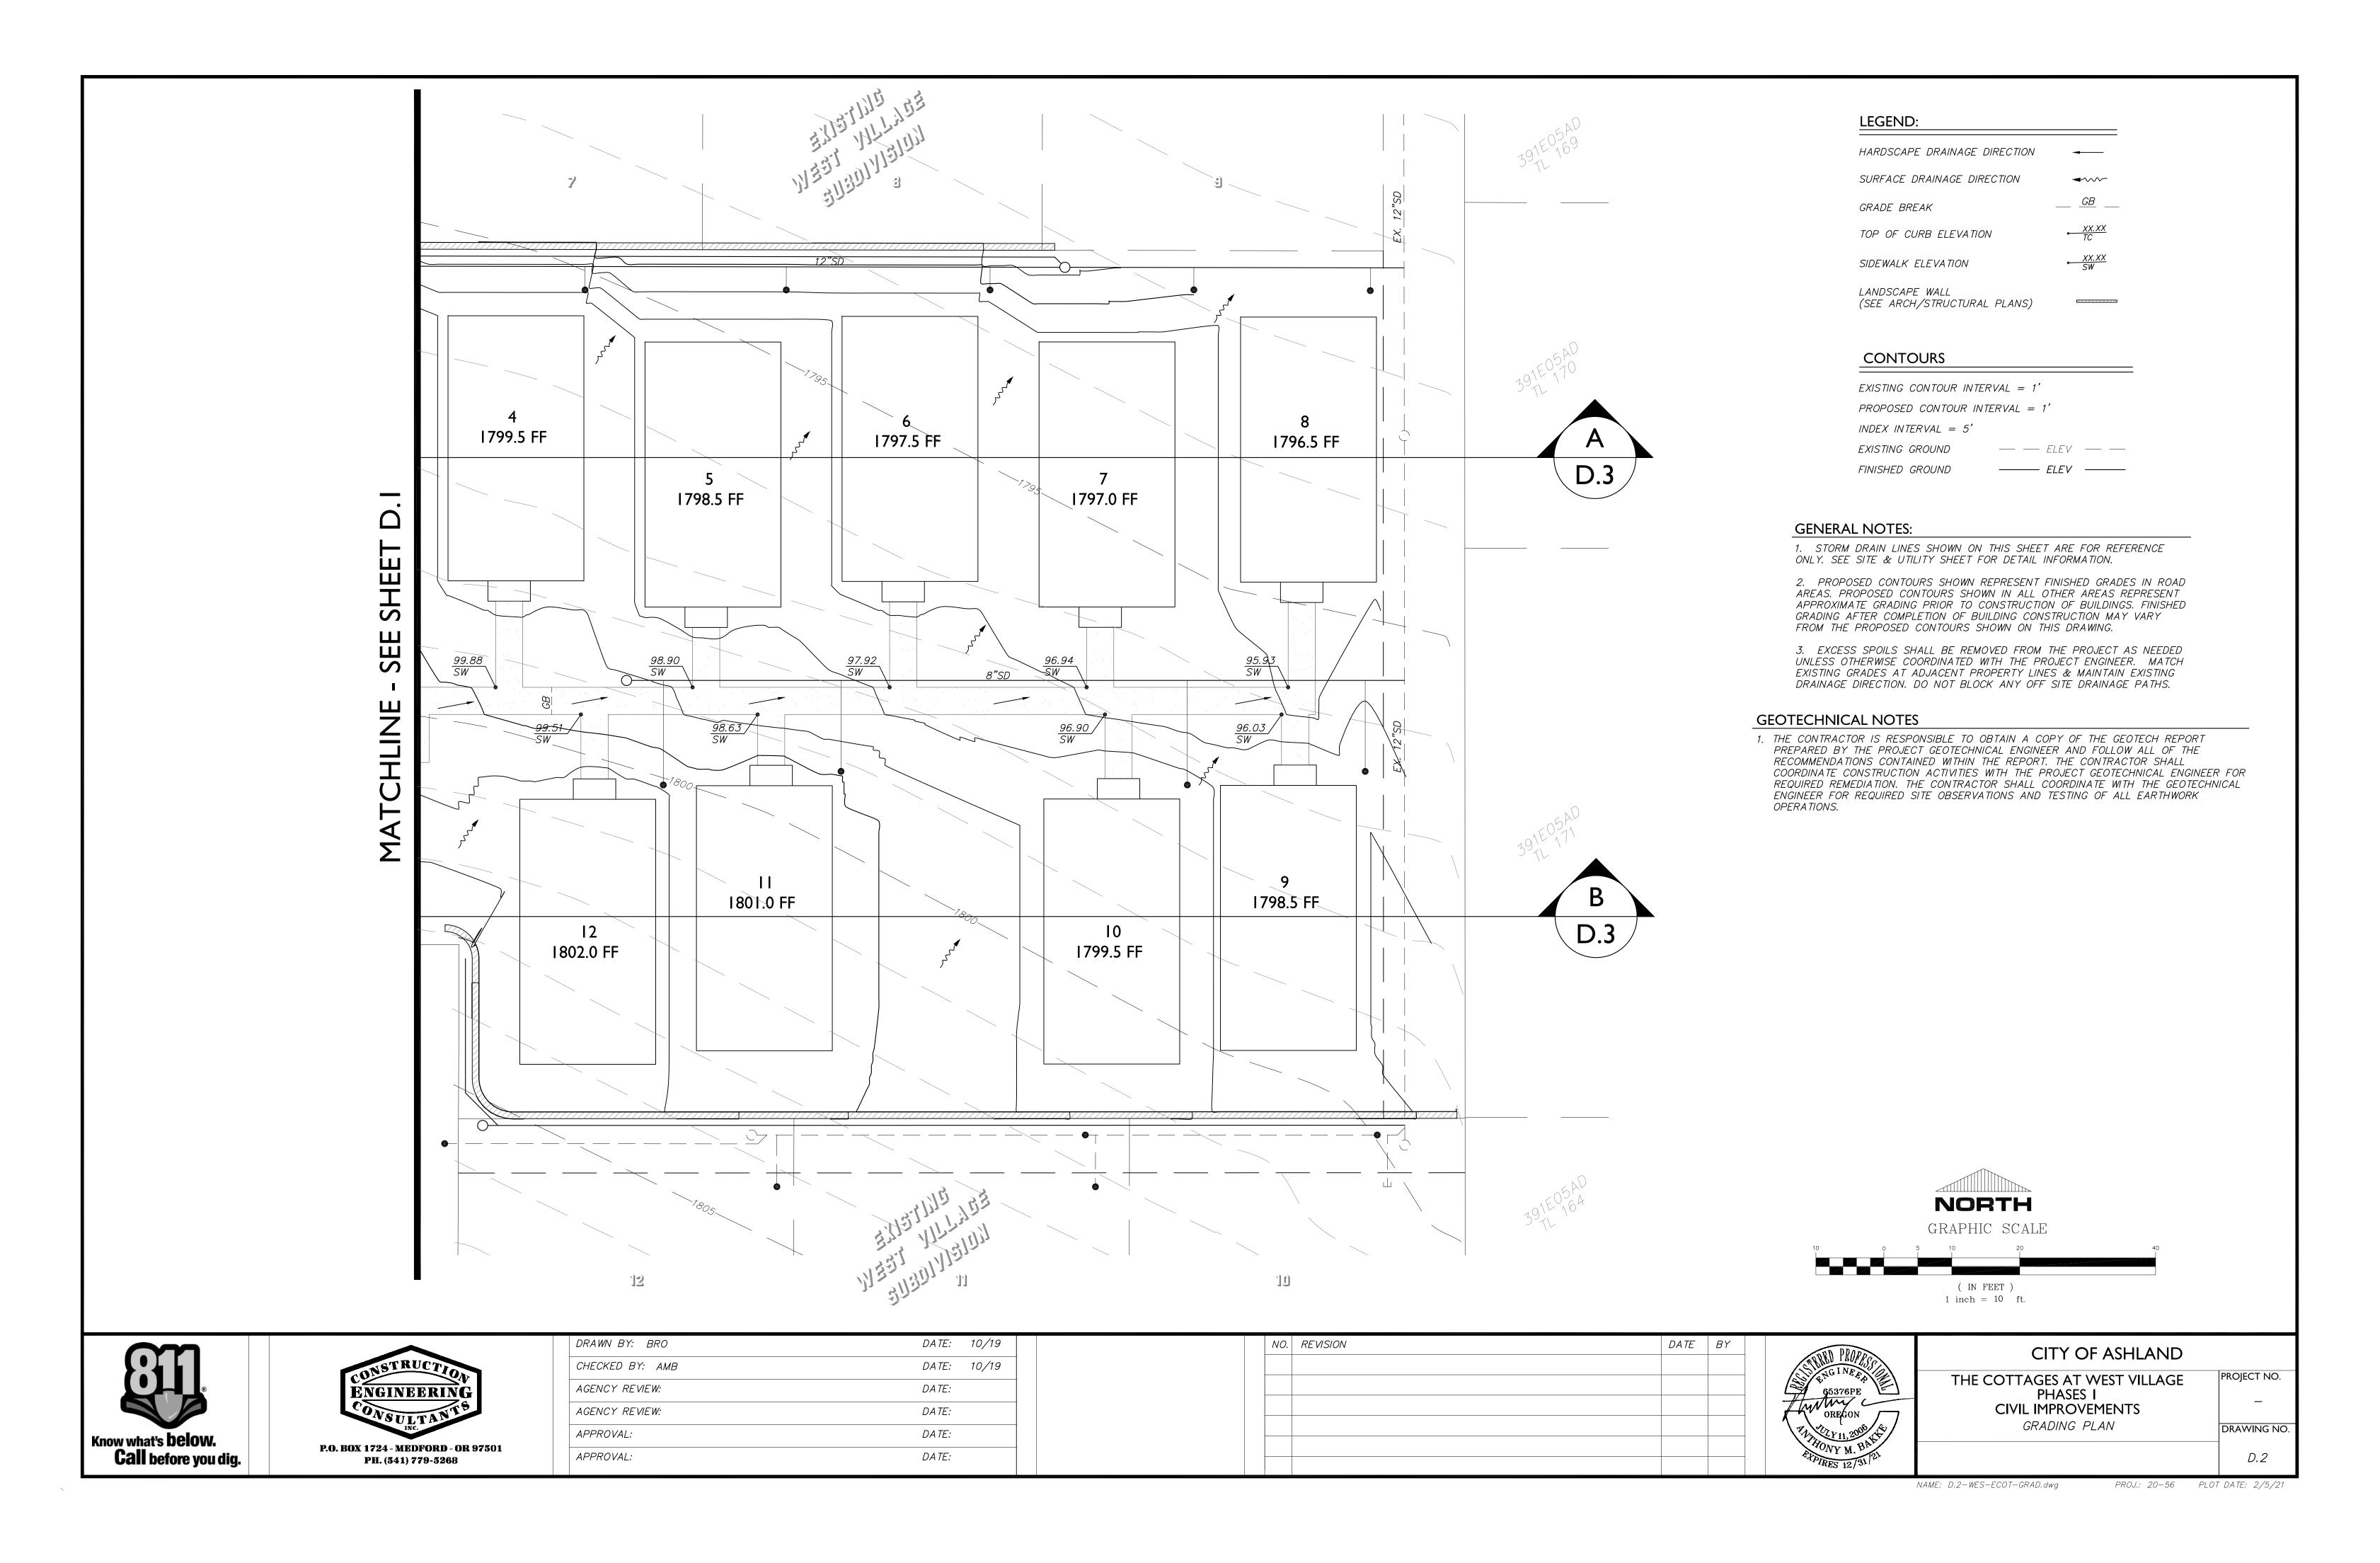

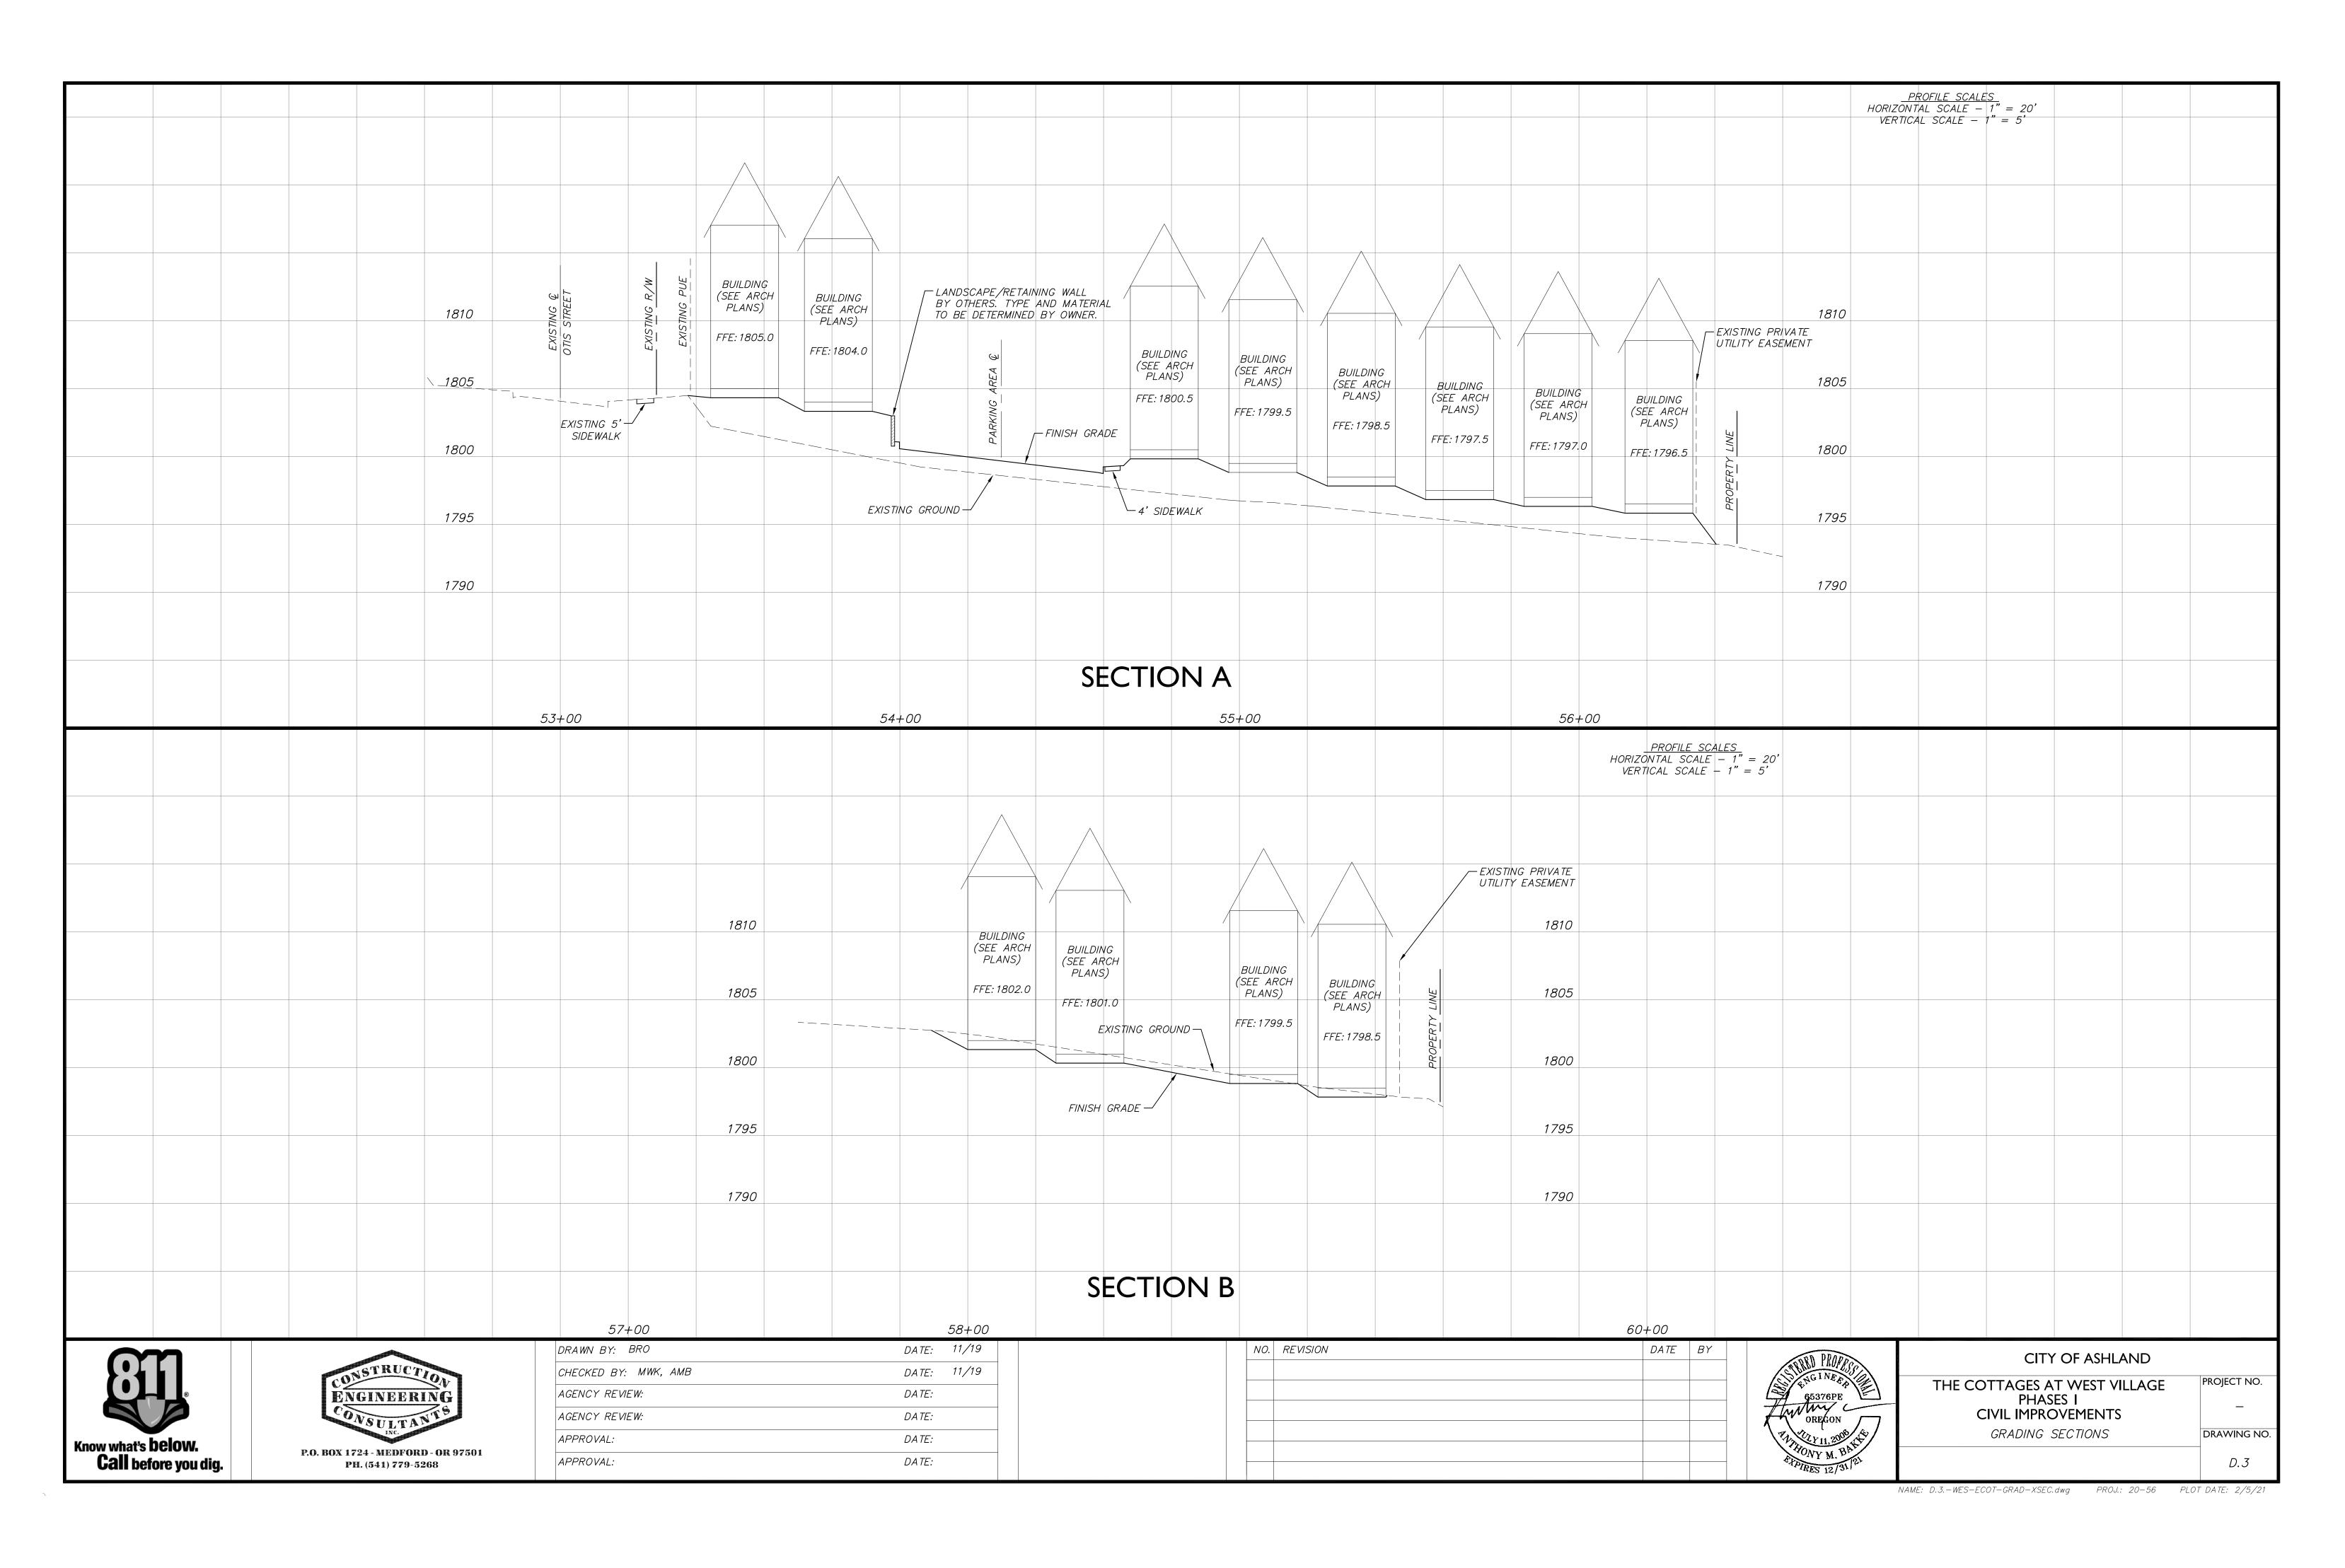

PART I: ESCP NARRATIVE FORM

PROJECT NAME: THE COTTAGES AT WEST VILLAGE, PHASE 1 PROJECT GREATER THAN 20 ACRES: NO SITE ACREAGE: 0.83 AC

DISTURBED AREA: 0.83 AC (THIS PROJECT IS INCLUDED W/ 1200-C PERMIT, DEQ FILE# 126873/EPA)
LOCATION: T. 39 S, R. 1 E., SECTION 5, W.M.

T. 39 S, R. 1 E., SECTION 5, W.M. TAX LOT 200 LATITUDE: 42.208487° LONGITUDE: -122.719855°

APPLICANT NAME: TAYLORED ELEMENTS
CONTACT: KYLE TAYLOR
ADDRESS: 1236 DISK DRIVE, STE. A

TELEPHONE: (541)690–1617

ESC CONSTRUCTION NOTES:

TILTER FABRIC SEDIMENTATION FENCE INSTALLED AT THE LOCATIONS SHOWN PER DETAIL NO. RD1040, SHEET E.2.

*NOTE:

EXISTING SEDIMENTATION FENCE INSTALLED FOR WEST VILLAGE SUBDIVISION MAY BE USED PROVIDED IT IS WELL MAINTAINED.

PROPOSED AND EXISTING STORM DRAIN INLETS SHALL BE PROTECTED BY INLET BARRIERS PER DETAIL NO. RD1015, SHEET E.2.

CONCRETE WASH-OUT PER RD1070, SHEET E.2, OR APPROVED EQUAL. LOCATION MAY VARY.

NOTE

ROCKED CONSTRUCTION ENTRANCE NOT REQUIRED DUE TO PAVED ACCESS TO CONSTRUCTION SITE. CONTRACTOR TO INSURE THAT EXISTING PAVED AREA REMAINS CLEAR AND FREE OF DEBRIS.

SEEDING NOTES:

HYDROSEED SEED MIX:

35% HARD FESCUE 35% SHEEP FESCUE 10% CANADA BLUEGRASS 20% ANNUAL RYE

SEED SHALL BE APPLIED AT A MINIMUM RATE OF 75 LBS/ACRE.


THE CONTRACTOR SHALL APPLY A COMMERCIALLY PREPARED FERTILIZER WITH THE ANALYSIS OF 16-20-0-14, APPLIED AT A RATE OF 250 LBS/ACRE.


MULCH SHALL BE APPLIED AT A RATE OF 2000 LBS/ACRE. MULCH SHALL BE VIRGIN WOOD CELLULOSE FIBER SPECIFICALLY PROCESSED AS A HYDROSEEDING MULCH AND CONTAIN NO GROWTH OR GERMINATION INHIBITING FACTORS.

TACKIFIER SHALL BE APPLIED AT THE RATE OF 40 POUNDS PER ACRE.

NOTE

CONTRACTOR TO PHASE CLEARING AND GRADING TO THE MAXIMUM EXTENT POSSIBLE TO PREVENT AREAS OF EROSION. CONTRACTOR TO APPLY TEMPORARY HYDROSEED OR OTHER APPROVED BMP TO ANY AREA THAT IS CLEARED AND NOT TO BE WORKED WITHIN A 14 DAY PERIOD.

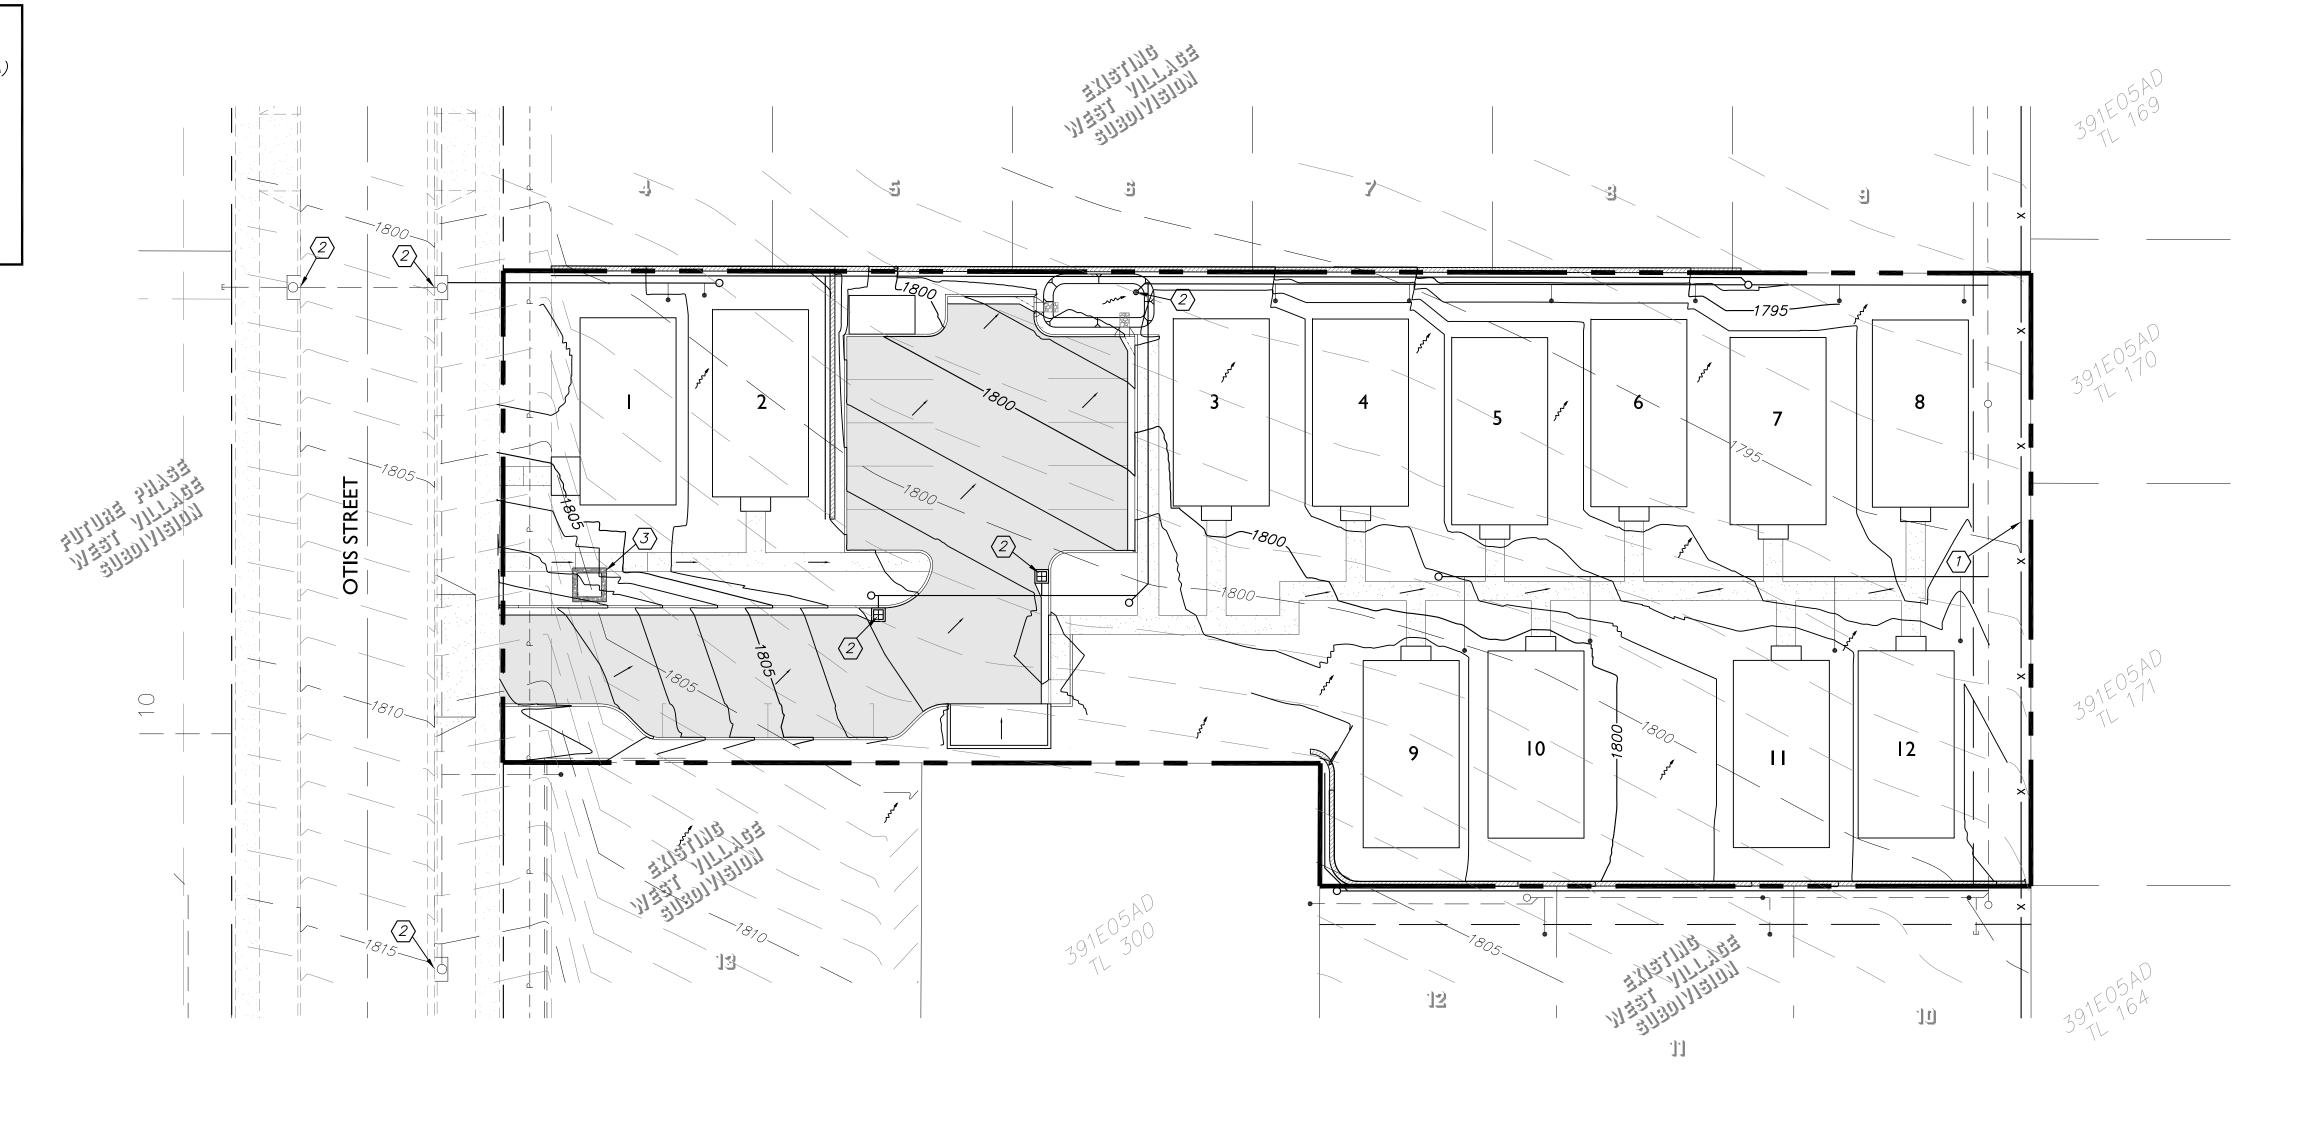

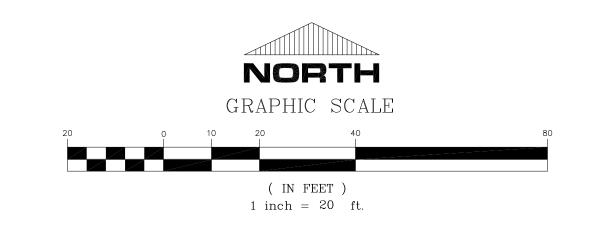

CONTOURS

CONTOUR INTERVAL = 1'

INDEX INTERVAL = 5'

EXISTING GROUND

FINISHED GROUND ——— ELEV ———

CONTRACTOR SHALL BE
ADVISED THAT THIS PLAN
IS FOR EROSION CONTROL
PURPOSES ONLY.


— — ELEV — —





DRAWN BY: BRO	DATE:	10/19	
CHECKED BY: AMB	DATE:	10/19	
AGENCY REVIEW:	DATE:		
AGENCY REVIEW:	DATE:		
APPROVAL:	DATE:		
APPROVAL:	DATE:		

	NO.	REVISION	DATE	BY	
					Ŀ
					1

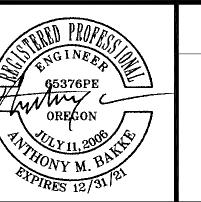

CITY OF ASHLAND THE COTTAGES AT WEST VILLAGE

PHASE I

CIVIL IMPROVEMENTS

EROSION & SEDIMENT CONTROL PLAN

PROJECT NO.


—


DRAWING NO.


E.1

PLOT DATE: 2/5/21

NAME: E.1-WES-ECOT-EROS.dwg PROJ.: 20-56

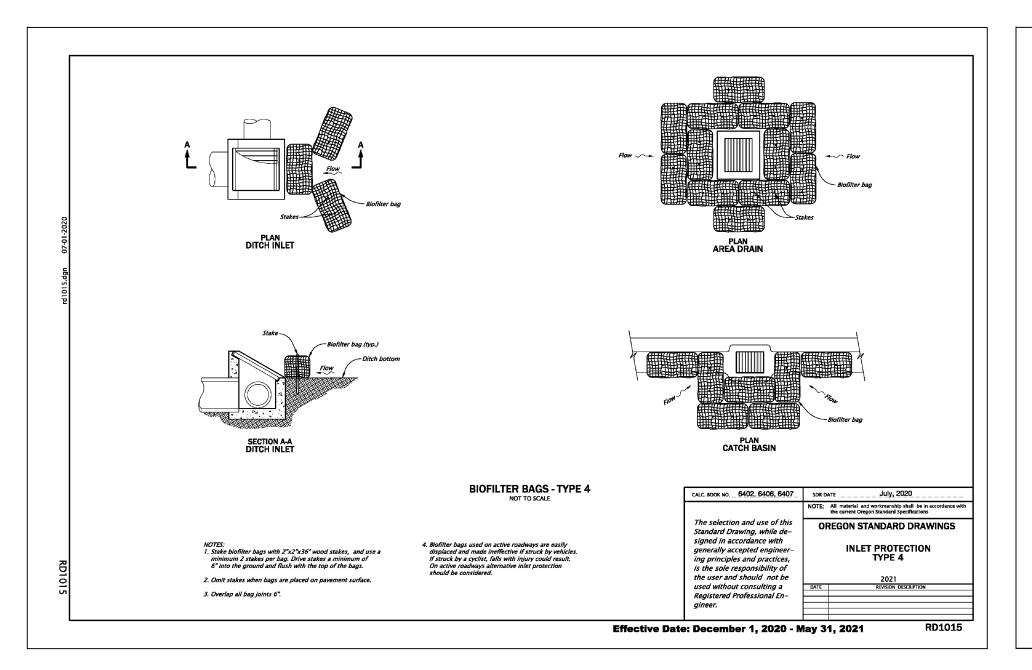

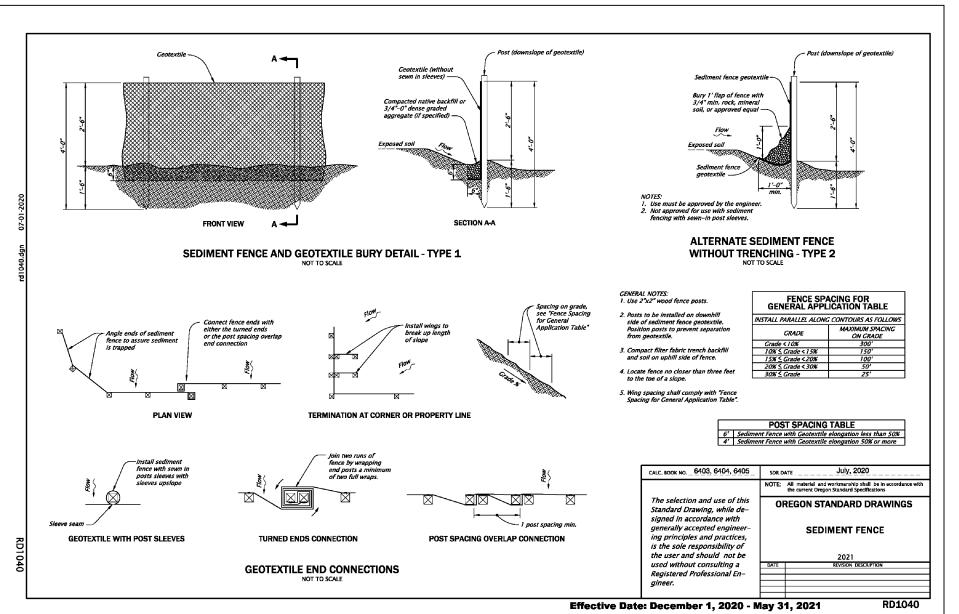

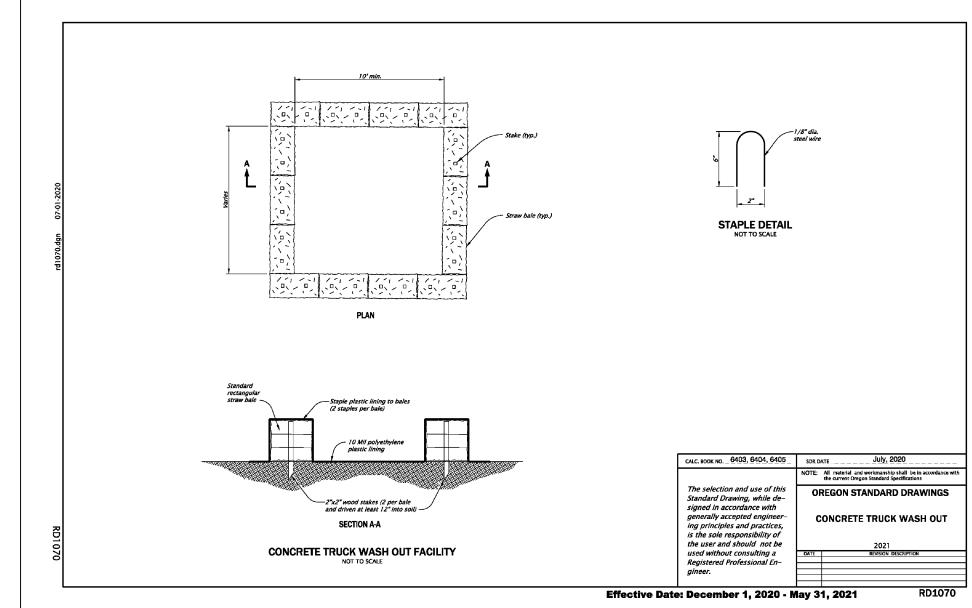






DRAWN BY: BRO	DATE:	10/19	
CHECKED BY: AMB	DATE:	10/19	
AGENCY REVIEW:	DATE:		
AGENCY REVIEW:	DATE:		
APPROVAL:	DATE:		
APPROVAL:	DATE:		

NO.	REVISION	DATE	BY

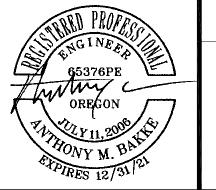

CITY OF ASHLAND

THE COTTAGES AT WEST VILLAGE
PHASE I
CIVIL IMPROVEMENTS


EROSION & SEDIMENT CONTROL PLAN


DRAWING NO.


PLOT DATE: 2/5/21


PROJECT NO.


NAME: E.1-WES-ECOT-EROS.dwg PROJ.: 20-56

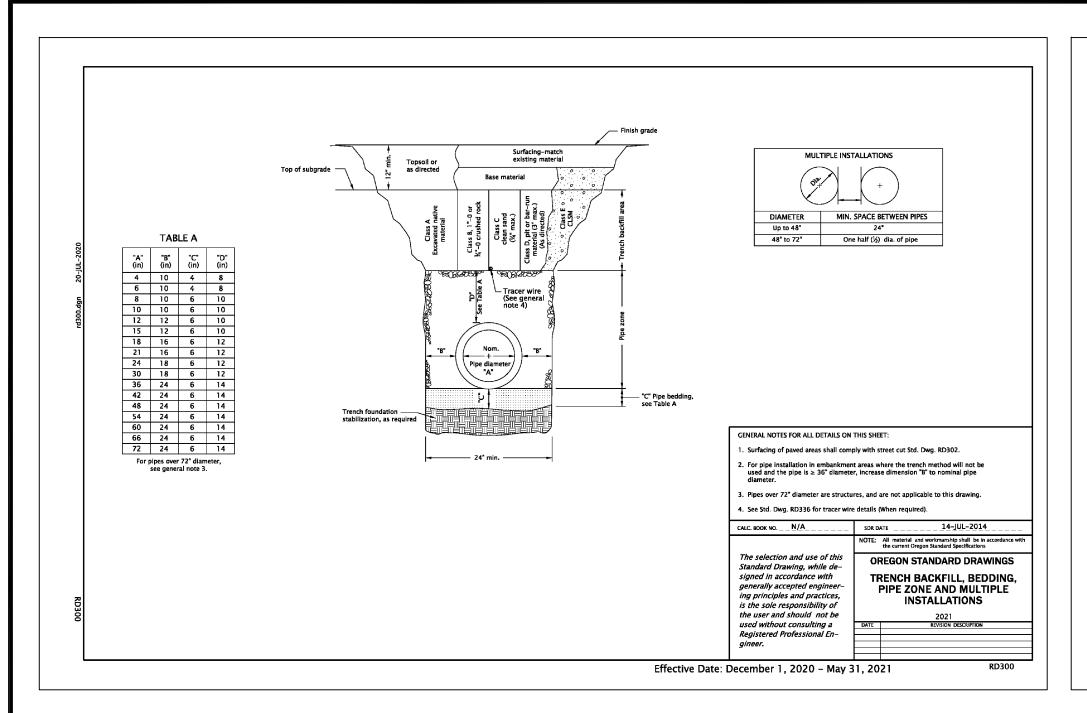


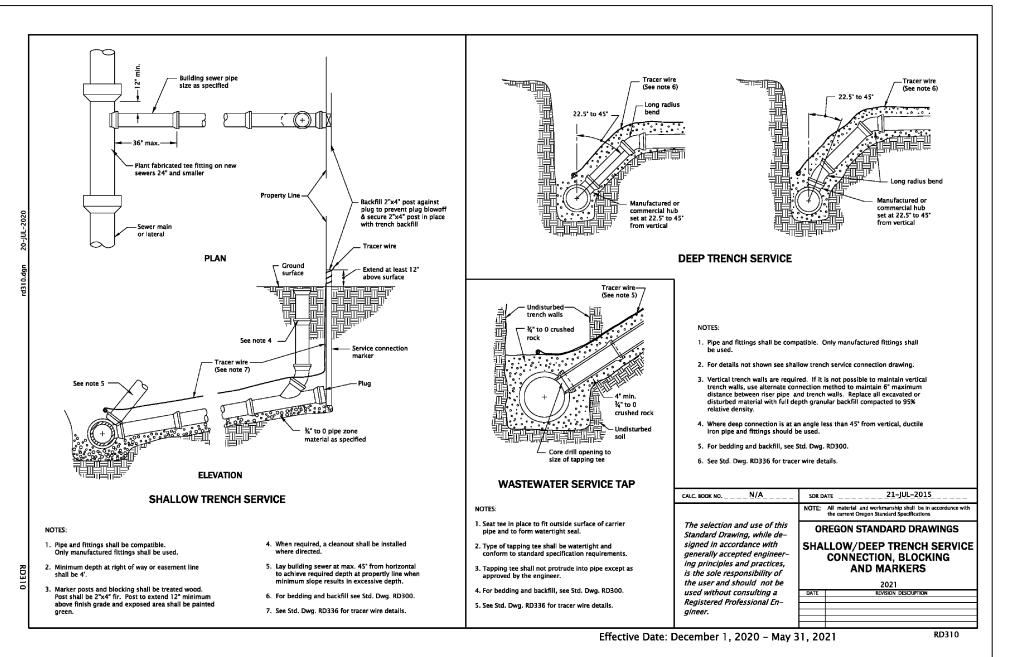

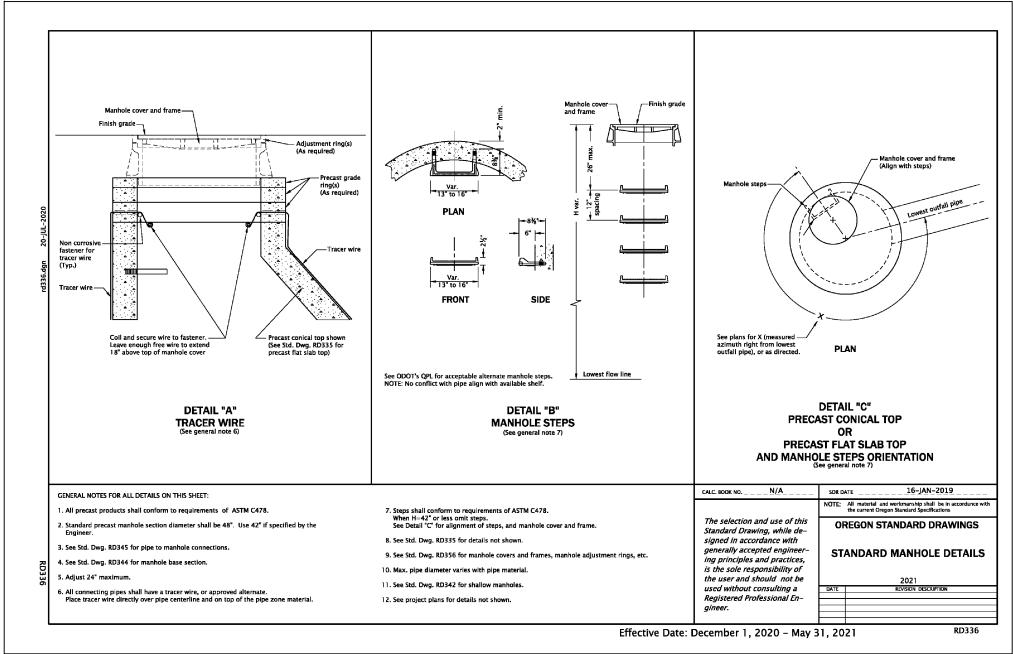

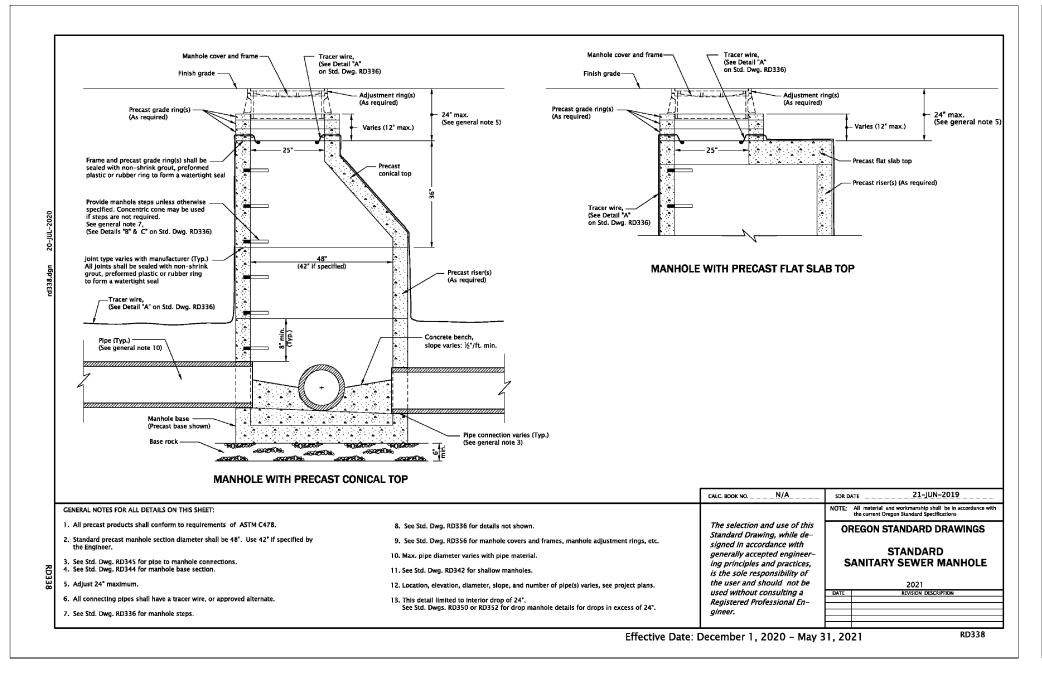

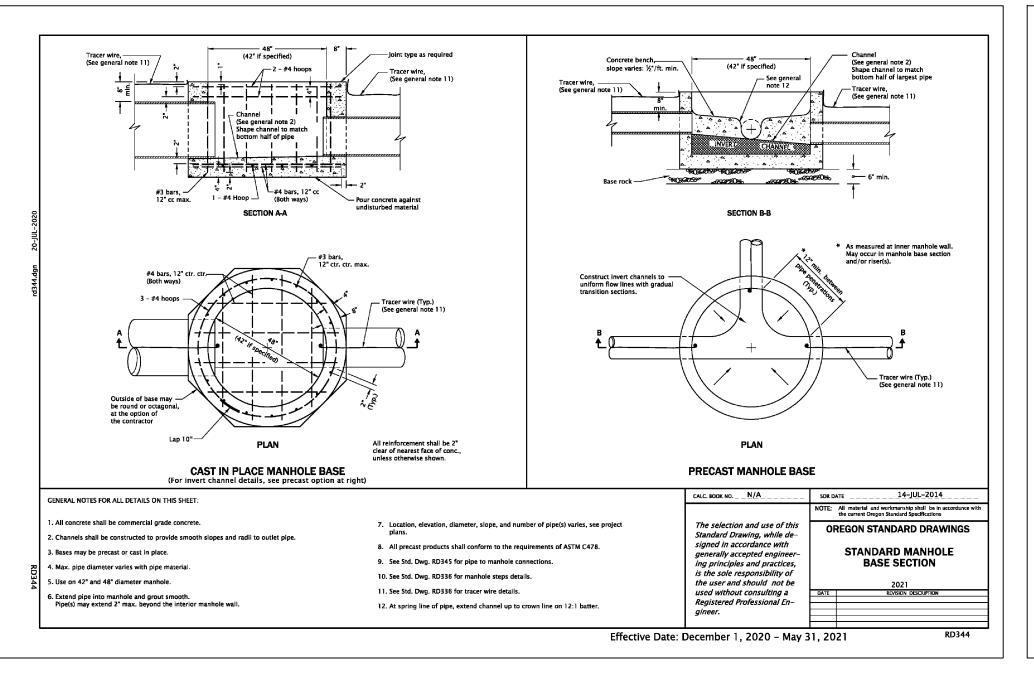

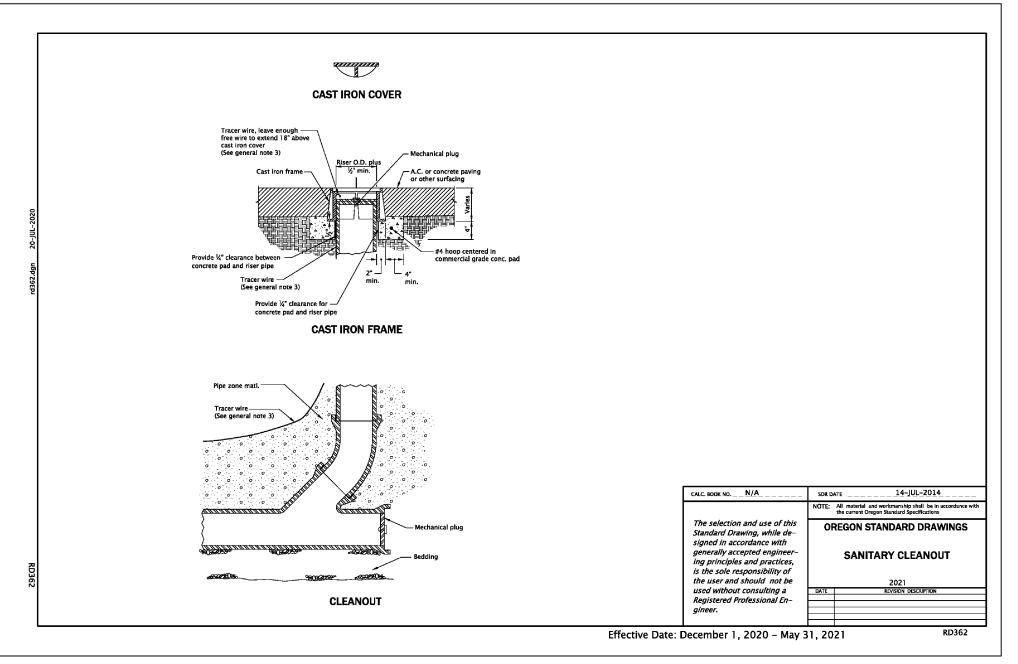


ALL STANDARD DETAILS ARE PROVIDED FOR REFERENCE ONLY!!! IT IS THE CONTRACTOR'S RESPONSIBILITY TO VERIFY AND USE THE MOST CURRENT CITY ACCEPTED STANDARD DETAILS.







DRAWN BY: BRO	DATE:	10/19	
CHECKED BY: AMB	DATE:	10/19	
AGENCY REVIEW:	DATE:		
AGENCY REVIEW:	DATE:		
APPROVAL:	DATE:		
APPROVAL:	DATE:		
			_


	NO.	REVISION	DATE	BY	
					,
					7

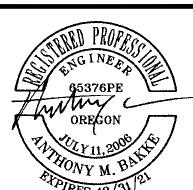



CITY OF ASHLAND	
THE COTTAGES AT WEST VILLAGE PHASES I CIVIL IMPROVEMENTS	PROJECT NO.
DETAILS	DRAWING NO.
	F.1

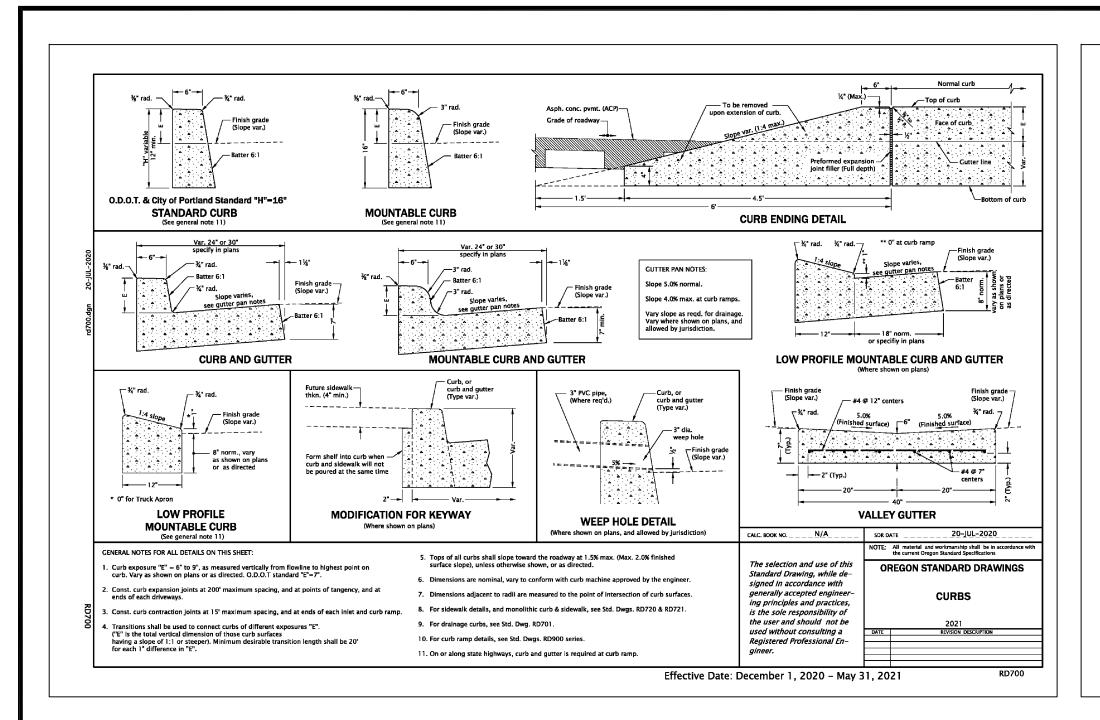

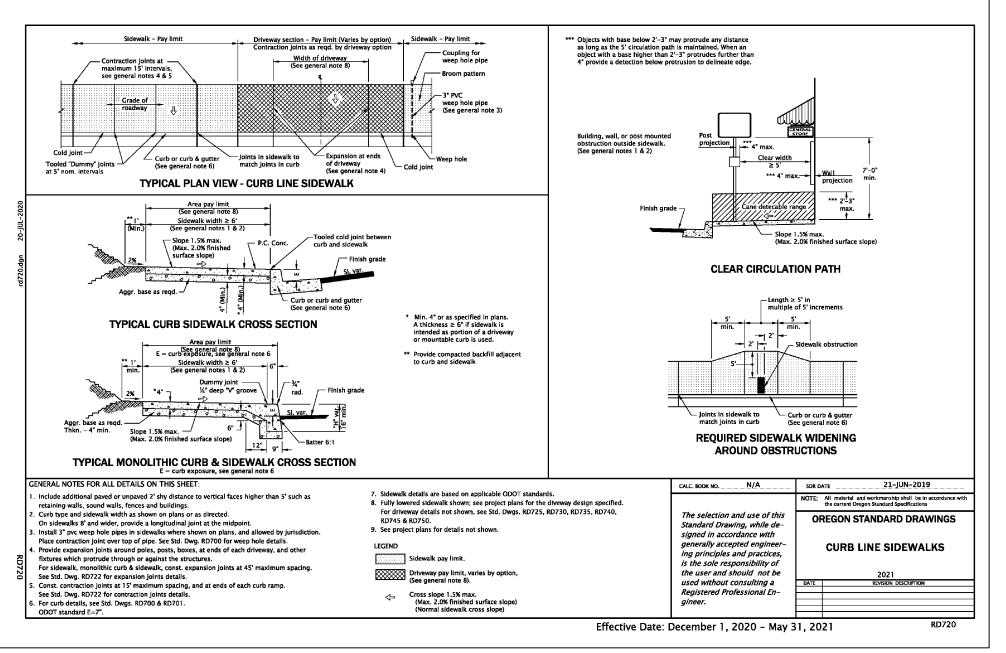

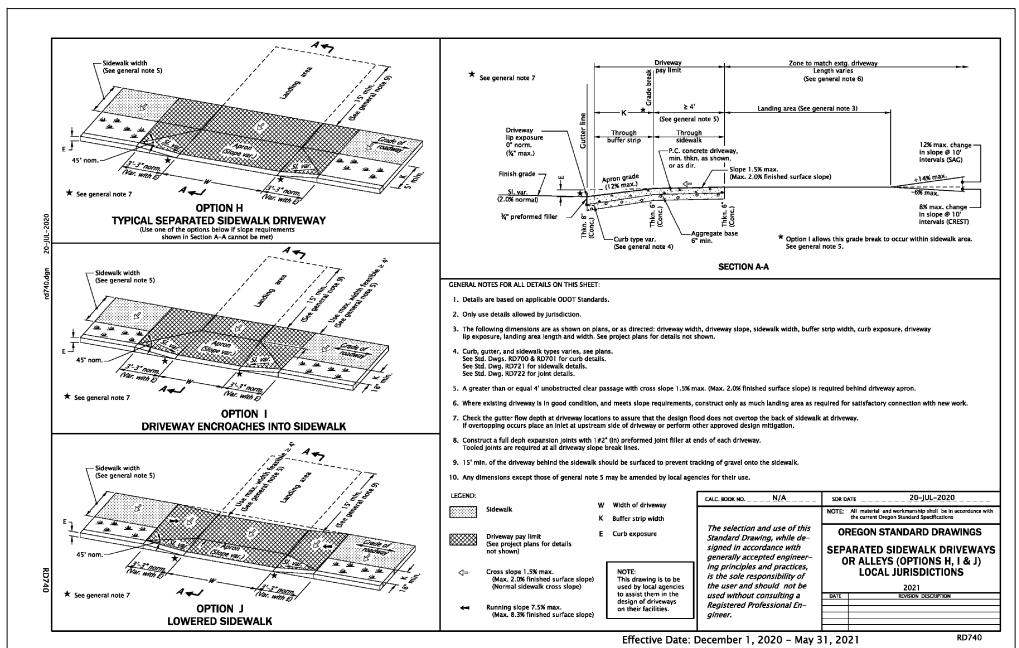

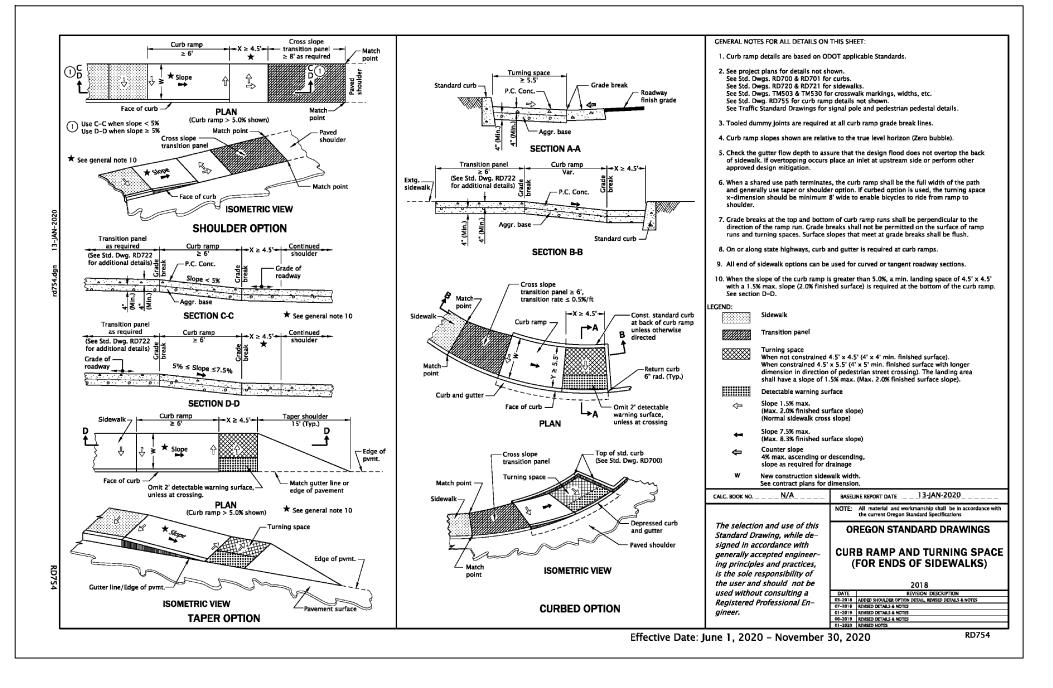

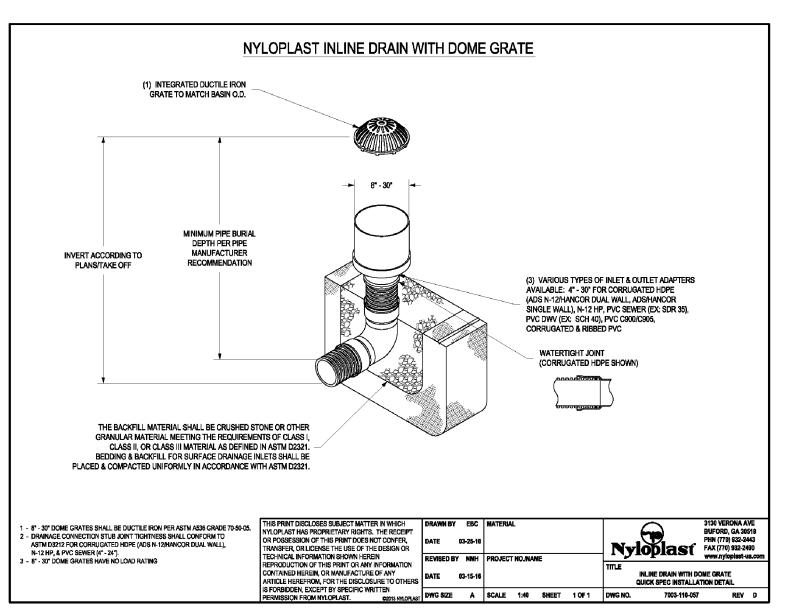


ALL STANDARD DETAILS ARE PROVIDED FOR REFERENCE ONLY!!! IT IS THE CONTRACTOR'S RESPONSIBILITY TO VERIFY AND USE THE MOST CURRENT CITY ACCEPTED STANDARD DETAILS.






DRAWN BY: BRO	DATE: 10/19
CHECKED BY: AMB	DATE: 10/19
AGENCY REVIEW:	DATE:
AGENCY REVIEW:	DATE:
APPROVAL:	DATE:
APPROVAL:	DATE:

	NO.	REVISION	DATE	BY	
					/
					Z

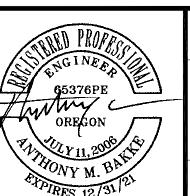


CITY OF ASHLAND	
THE COTTAGES AT WEST VILLAGE PHASES I CIVIL IMPROVEMENTS	PROJECT NO.
DETAILS	DRAWING NO.
	F.2

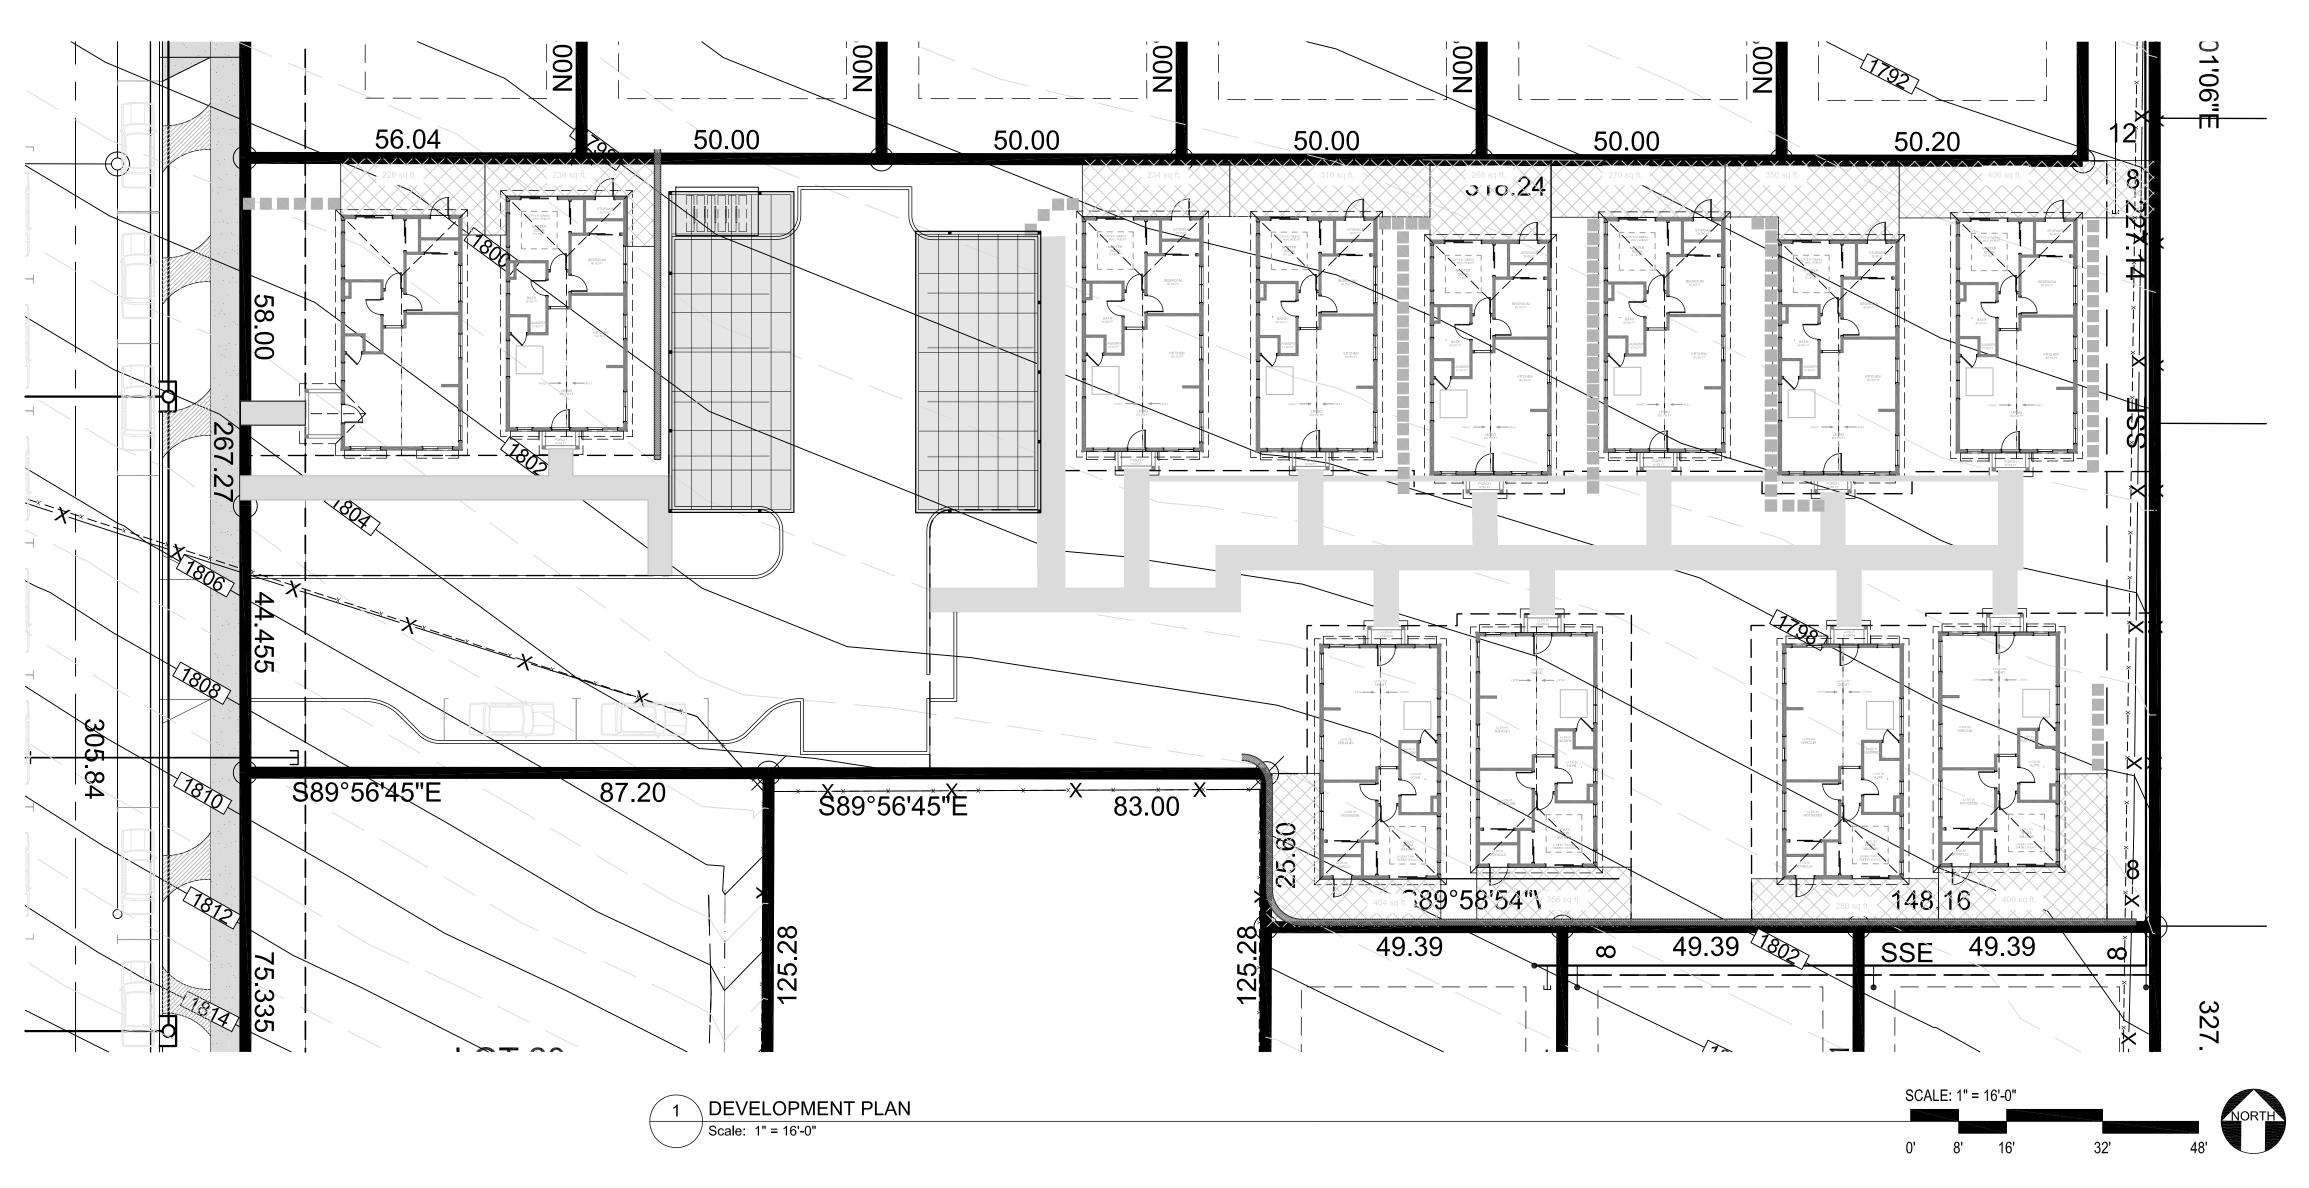





TAX LOT (NUMBER)	LOT 391E05AD	200	
LOT	SIZE	0.86 Ac - 37,541	SF	
ZON	ING DESIGNATION	R-1-5 AND R-1-	5-P	
NUM	BER OF UNITS	12 @ 925 SF (R0	OOF COVER)	29.5 %
PAVE	ED SURFACE	7,309 SF (5,526	PKG ETC - 1,783 SW)	19.4 %
PER	CENT LANDSCAPE	PERVIOUS LAN	DSCAPE	51.1%
SHEET	KEY			
COVER	COVER + SITE PLAN			
L1.0	TREE PROTECTION PLAN			
L2.0	SITE PLAN - OPEN SPACE			
L3.0	LANDSCAPE IRRIGATION F	PLAN		
L3.1	LANDSCAPE IRRIGATION D	ETAILS		
L4.0	LANDSCAPE PLANTING PLA	AN		
L4.1	LANDSCAPE PLANTING DE	TAILS		

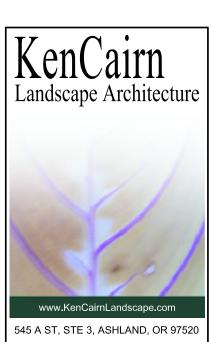

541.488.3194



DRAWN BY:


WE ATS TAGE THE COTT OTIS STREET ASHLAND, OR,

> JOB NO. 1921 **REVISION DATE**

97520

COVER


ISSUE DATE: 02/08/21

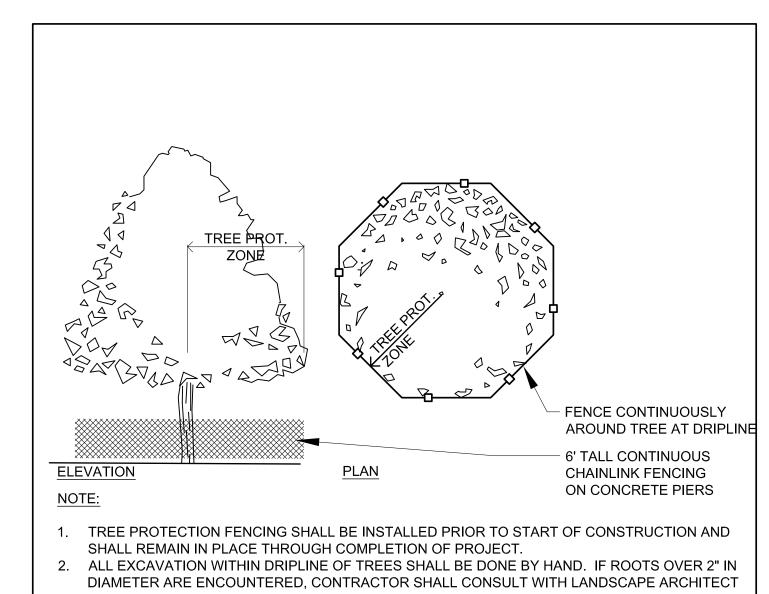


- OR ARBORIST BEFORE PROCEEDING
- 3. TREE ROOTS ENCOUNTERED DURING CONSTRUCTION, SHALL BE CUT CLEANLY AT A 90 DEGREE ANGLE AND PACKED WITH DAMP SOIL IMMEDIATELY.
- 4. DURING CONSTRUCTION ALL TREES TO REMAIN SHALL BE IRRIGATED ON A WEEKLY BASIS OR AS NECESSARY WITH LEAKY PIPE ENCIRCLING THE TREE FROM TRUNK OUT TO DRIP LINE.

│ DETAIL: TREE PROTECTION FENCING

Scale: NTS

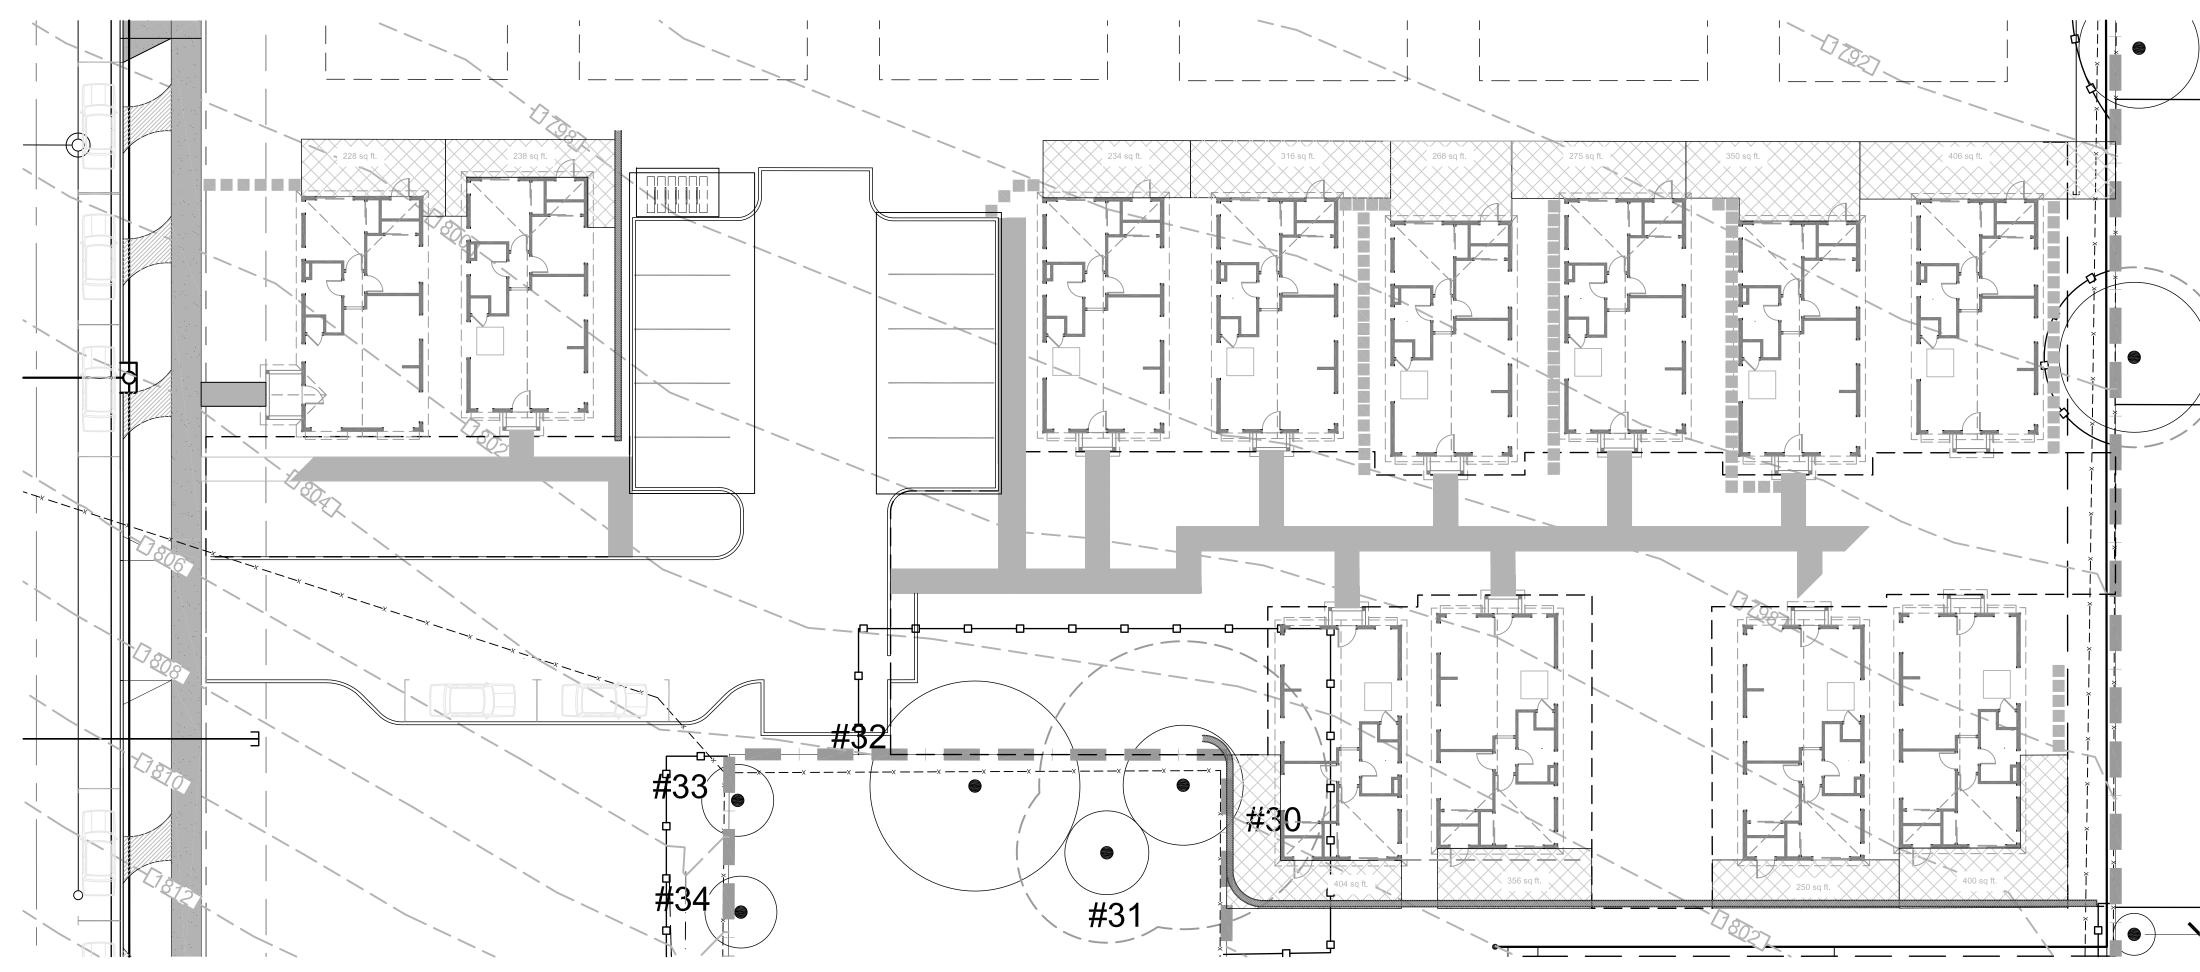

THE TREE PROTECTION ZONE FOR EACH TREE IS BASED ON THE GUIDELINES ESTABLISHED BY: Matheny, N. & Clark, J. 1998. Trees and Development: A Technical Guide to Preservation of Trees During Land Development. p. 72.

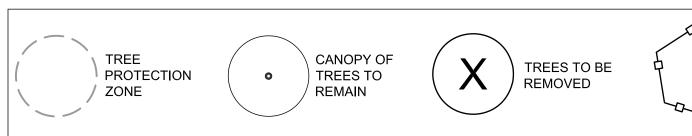

TREE PROTECTION AND REMOVAL NOTES

AND LABELED FOR THAT USE.

COMPLETE.

- PRIOR TO DELIVERING EXCAVATION EQUIPMENT OR COMMENCING ANY CONSTRUCTION ACTIVITIES ON THE SITE, THE GENERAL CONTRACTOR SHALL CONTACT THE LANDSCAPE ARCHITECT FOR A PRE-CONSTRUCTION MEETING WITH THE LANDSCAPE ARCHITECT AND EXCAVATION SUPERVISOR PRIOR TO COMMENCING ANY WORK ON THE SITE. THE LANDSCAPE ARCHITECT SHALL BE NOTIFIED BY THE CONTRACTOR 48 HRS. IN ADVANCE FOR ALL SITE VISITS 12. BEFORE GRADING, PAD PREPARATION, OR EXCAVATION FOR THE FOUNDATIONS, FOOTINGS REQUESTED. CONTRACTOR SHALL OBTAIN WRITTEN APPROVAL FROM THE OWNER'S REPRESENTATIVE THAT CONSTRUCTION MAY BEGIN AFTER ALL OF THE DESCRIBED FENCING IS IN PLACE. FENCING SHALL REMAIN IN PLACE UNTIL THE PROJECT IS COMPLETED.
- FENCES MUST BE ERECTED TO PROTECT TREES TO BE PRESERVED AS SHOWN IN DIAGRAM. FENCING SHALL BE 6' TALL TEMPORARY CHAIN LINK PANELS INSTALLED WITH METAL CONNECTIONS TO ALL PANELS AREA INTEGRATED, THESE FENCES SHALL BE INSTALLED SO THAT 13. ANY ROOTS DAMAGED DURING GRADING OR CONSTRUCTION SHALL BE EXPOSED TO SOUND IT DOES NOT ALLOW PASSAGE OF PEDESTRIANS AND/ OR VEHICLES THROUGH IT. FENCES DEFINE A SPECIFIC PROTECTION ZONE FOR EACH TREE OR GROUP OF TREES. FENCES ARE TO REMAIN UNTIL ALL SITE WORK HAS BEEN COMPLETED. FENCES MAY NOT BE RELOCATED OR REMOVED WITHOUT THE PERMISSION OF THE LANDSCAPE ARCHITECT.
- CONSTRUCTION TRAILERS, TRAFFIC AND STORAGE AREAS MUST REMAIN OUTSIDE FENCED TREE PROTECTION ZONES AT ALL TIMES.
- ALL PROPOSED UNDERGROUND UTILITIES AND DRAIN OR IRRIGATION LINES SHALL BE ROUTED OUTSIDE THE TREE PROTECTION ZONE. IF LINES MUST TRANSVERSE THE PROTECTION AREA, THEY SHALL BE TUNNELED OR BORED UNDER THE TREE ROOTS. NOTIFY THE LANDSCAPE
- NO MATERIALS, EQUIPMENT, SPOIL, OR WASTE OR WASHOUT WATER MAY BE DEPOSITED, STORED, OR PARKED WITHIN THE TREE PROTECTION ZONE (FENCED AREA).

ARCHITECT IMMEDIATELY IF ANY PROJECT PLANS CONFLICT WITH THIS REQUIREMENT.

- NOTIFY THE LANDSCAPE ARCHITECT IF TREE PRUNING IS REQUIRED CONSTRUCTION CLEARANCE IGNITION SOURCES, OR SMOKING IS ALLOWED NEAR MULCH OR TREES.
- ANY HERBICIDES PLACED UNDER PAVING MATERIALS MUST BE SAFE FOR USE AROUND TREES
- IF INJURY SHOULD OCCUR TO ANY TREE DURING CONSTRUCTION, NOTIFY THE LANDSCAPE ARCHITECT IMMEDIATELY. ALL DAMAGE CAUSED BY CONSTRUCTION TO EXISTING TREES SHALL BE COMPENSATED FOR BY THE OFFENDING PARTY, BEFORE THE PROJECT WILL BE CONSIDERED 20. EXCEPTIONS TO THE TREE PROTECTION SPECIFICATIONS MAY ONLY BE GRANTED IN
- . WATERING SCHEDULE: WATERING PROTECTED TREES SHALL FOLLOW THESE STANDARDS,
- LESS WATER THAN RECOMMENDED IN THESE NOTES. A. MOST SPECIES: 1 TIME PER MONTH DURING IRRIGATION SEASON (USUALLY MARCH THROUGH
- B. QUERCUS/OAK: DEEP WATER IN MAY AND SEPTEMBER, DO NOT WATER DURING OTHER MONTHS. FOR OAKS ALREADY IN THE VICINITY OF IRRIGATED CONDITIONS, AUTOMATIC SPRINKLERS OR REGULAR WATERING SHALL NOT BE ALLOWED TO SPRAY ON OR WITHIN 3 FEET OF THE TRUNK. THE WATER SHALL NOT BE ALLOWED TO POOL OR DRAIN TOWARDS
- C. WATERING METHOD: HAND WATERING SYSTEMS, RECOMMENDED FOR TREES THAT ARE PART OF A DEVELOPMENT PROJECT THAT MUST BE WATERED TO INSURE TREE SURVIVAL DURING

THE COURSE OF CONSTRUCTION UNTIL AUTOMATIC IRRIGATION IS INSTALLED. 11. EROSION CONTROL DEVICES SUCH AS SILT FENCING, DEBRIS BASINS, AND WATER DIVERSION STRUCTURES SHALL BE INSTALLED ON THE UPHILL SIDE OF THE TREE PROTECTION ZONE TO PREVENT SILTATION AND/ OR EROSION WITHIN THE TREE PROTECTION ZONE. WALLS, OR TRENCHING, ANY TREES WITHIN THE SPECIFIC CONSTRUCTION ZONE SHALL BE ROOT PRUNED 1 FOOT OUTSIDE THE TREE PROTECTION ZONE BY CUTTING ALL ROOTS CLEANLY AT A 90 DEGREE ANGLE TO A DEPTH OF 24 INCHES. ROOTS SHALL BE CUT BY MANUALLY DIGGING A TRENCH AND CUTTING EXPOSED ROOTS WITH A SAW, VIBRATING KNIFE, ROCK SAW, NARROW TRENCHER WITH SHARP BLADES, OR OTHER APPROVED ROOT-PRUNING EQUIPMENT.

PROTECTION

FENCING

TISSUE AND CUT CLEANLY AT A 90 DEGREE ANGLE TO THE ROOT WITH A SAW. PLACE DAMP SOIL AROUND ALL CUT ROOTS TO A DEPTH EQUALING THE EXISTING FINISH GRADE WITHIN 4 HOURS OF CUTS BEING MADE.

- 14. IF TEMPORARY HAUL OR ACCESS ROADS MUST PASS OVER THE ROOT AREA OF TREES TO BE RETAINED, A ROAD BED OF 6 INCHES OF MULCH OR GRAVEL SHALL BE CREATED TO PROTECT THE SOIL. THE ROAD BED MATERIAL SHALL BE REPLENISHED AS NECESSARY TO MAINTAIN A 6 INCH
- 15. SPOIL FROM TRENCHES, BASEMENTS, OR OTHER EXCAVATIONS SHALL NOT BE PLACED WITHIN THE TREE PROTECTION ZONE, EITHER TEMPORARILY OR PERMANENTLY.
- 16. NO BURN PILES OR DEBRIS PILES SHALL BE PLACED WITHIN THE TREE PROTECTION ZONE. NO ASHES, DEBRIS, OR GARBAGE MAY BE DUMPED OR BURIED WITHIN THE TREE PROTECTION ZONE.
- 17. MAINTAIN FIRE-SAFE AREAS AROUND FENCED AREA. ALSO, NO HEAT SOURCES, FLAMES,
- 18. DO NOT RAISE THE SOIL LEVEL WITHIN THE DRIP LINES TO ACHIEVE POSITIVE DRAINAGE, EXCEPT TO MATCH GRADES WITH SIDEWALKS AND CURBS, AND IN THOSE AREAS, FEATHER THE ADDED TOPSOIL BACK TO EXISTING GRADE AT APPROXIMATELY 3:1 SLOPE.
- 19. REMOVE THE ROOT WAD FOR EACH TREE THAT IS INDICATED ON THE PLAN AS BEING REMOVED.
- EXTRAORDINARY CIRCUMSTANCES WITH WRITTEN APPROVAL FROM THE LANDSCAPE ARCHITECT PRIOR TO ANY WORK COMMENCING.

HOWEVER PERIODS OF EXTREME HEAT, WIND, RAINFALL OR DROUGHT MAY REQUIRE MORE OR 21. AS A PROTECTIVE MEASURE TO COMPENSATE FOR CONSTRUCTION IMPACTS, TWO TO SIX WEEKS PRIOR TO CONSTRUCTION, ALL RETAINED TREES SHOWN ON THIS PLAN SHALL RECEIVE AN APPLICATION OF MYCOAPPLY ALL PURPOSE SOLUBLE PER MANUFACTURER'S INSTRUCTIONS. THIS MYCORRHIZAE PRODUCT IS A SPECIALLY FORMULATED NATURAL ROOT BIOSTIMULANT WHICH ENHANCES THE ABSORPTIVE SURFACE AREA OF THE TREES' ROOT SYSTEMS. THIS PROMOTES AND IMPROVES NUTRIENT AND WATER UPTAKE CAPABILITIES OF THE REMAINING ROOT STRUCTURE. DISTRIBUTE MYCOAPPLY EVENLY WITHIN THE ACTIVE ROOT ZONE OF RETAINED TREES. APPLY 30 GALS. OF SOLUTION PER TREE 6" DBH AND GREATER, A MINIMUM OF 4" BELOW SOIL SURFACE IN QUANTITIES OF 1/2 GALLON AT EACH POINT OF APPLICATION. LOCATE THE ACTIVE ROOT ZONES WITH LANDSCAPE ARCHITECT PRESENT. MYCOAPPLY IS AVAILABLE FROM MYCORRHIZAL APPLICATION, INC., PHONE (541) 476-3985.

# Spe	ecies	DBH (Inches)	Height (Feet)	Crown Diameter (Feet)	Tree Protection Zone Radius (Feet)		Condition	Notes
1 Ace	er saccharinum	12"	30'	25'	15'	Poor	GOOD	OFF-SITE
2 Prur	nus sp.	6"	14'	18'	N/A	Good	GOOD	OFF-SITE
0 Pop	oulus tremuloides	(3) 8"	28'	20'	24'	Poor	GOOD	OFF-SITE
31 Pop	oulus tremuloides	12"	40'	10'	15'	Poor	GOOD	OFF-SITE
32 Prur	nus sp.	(multi)	30'	36'	N/A	Moderate	GOOD	OFF-SITE, MULTI-TRUNKS
3 Malı	us sp.	8"	16'	14'	N/A	Good	GOOD	OFF-SITE








DRAWN BY:


THE OTIS ASHL


JOB NO. 1921 REVISION DATE

SITE TREE **PRESERVATION** PLAN

> ISSUE DATE: 02/08/21

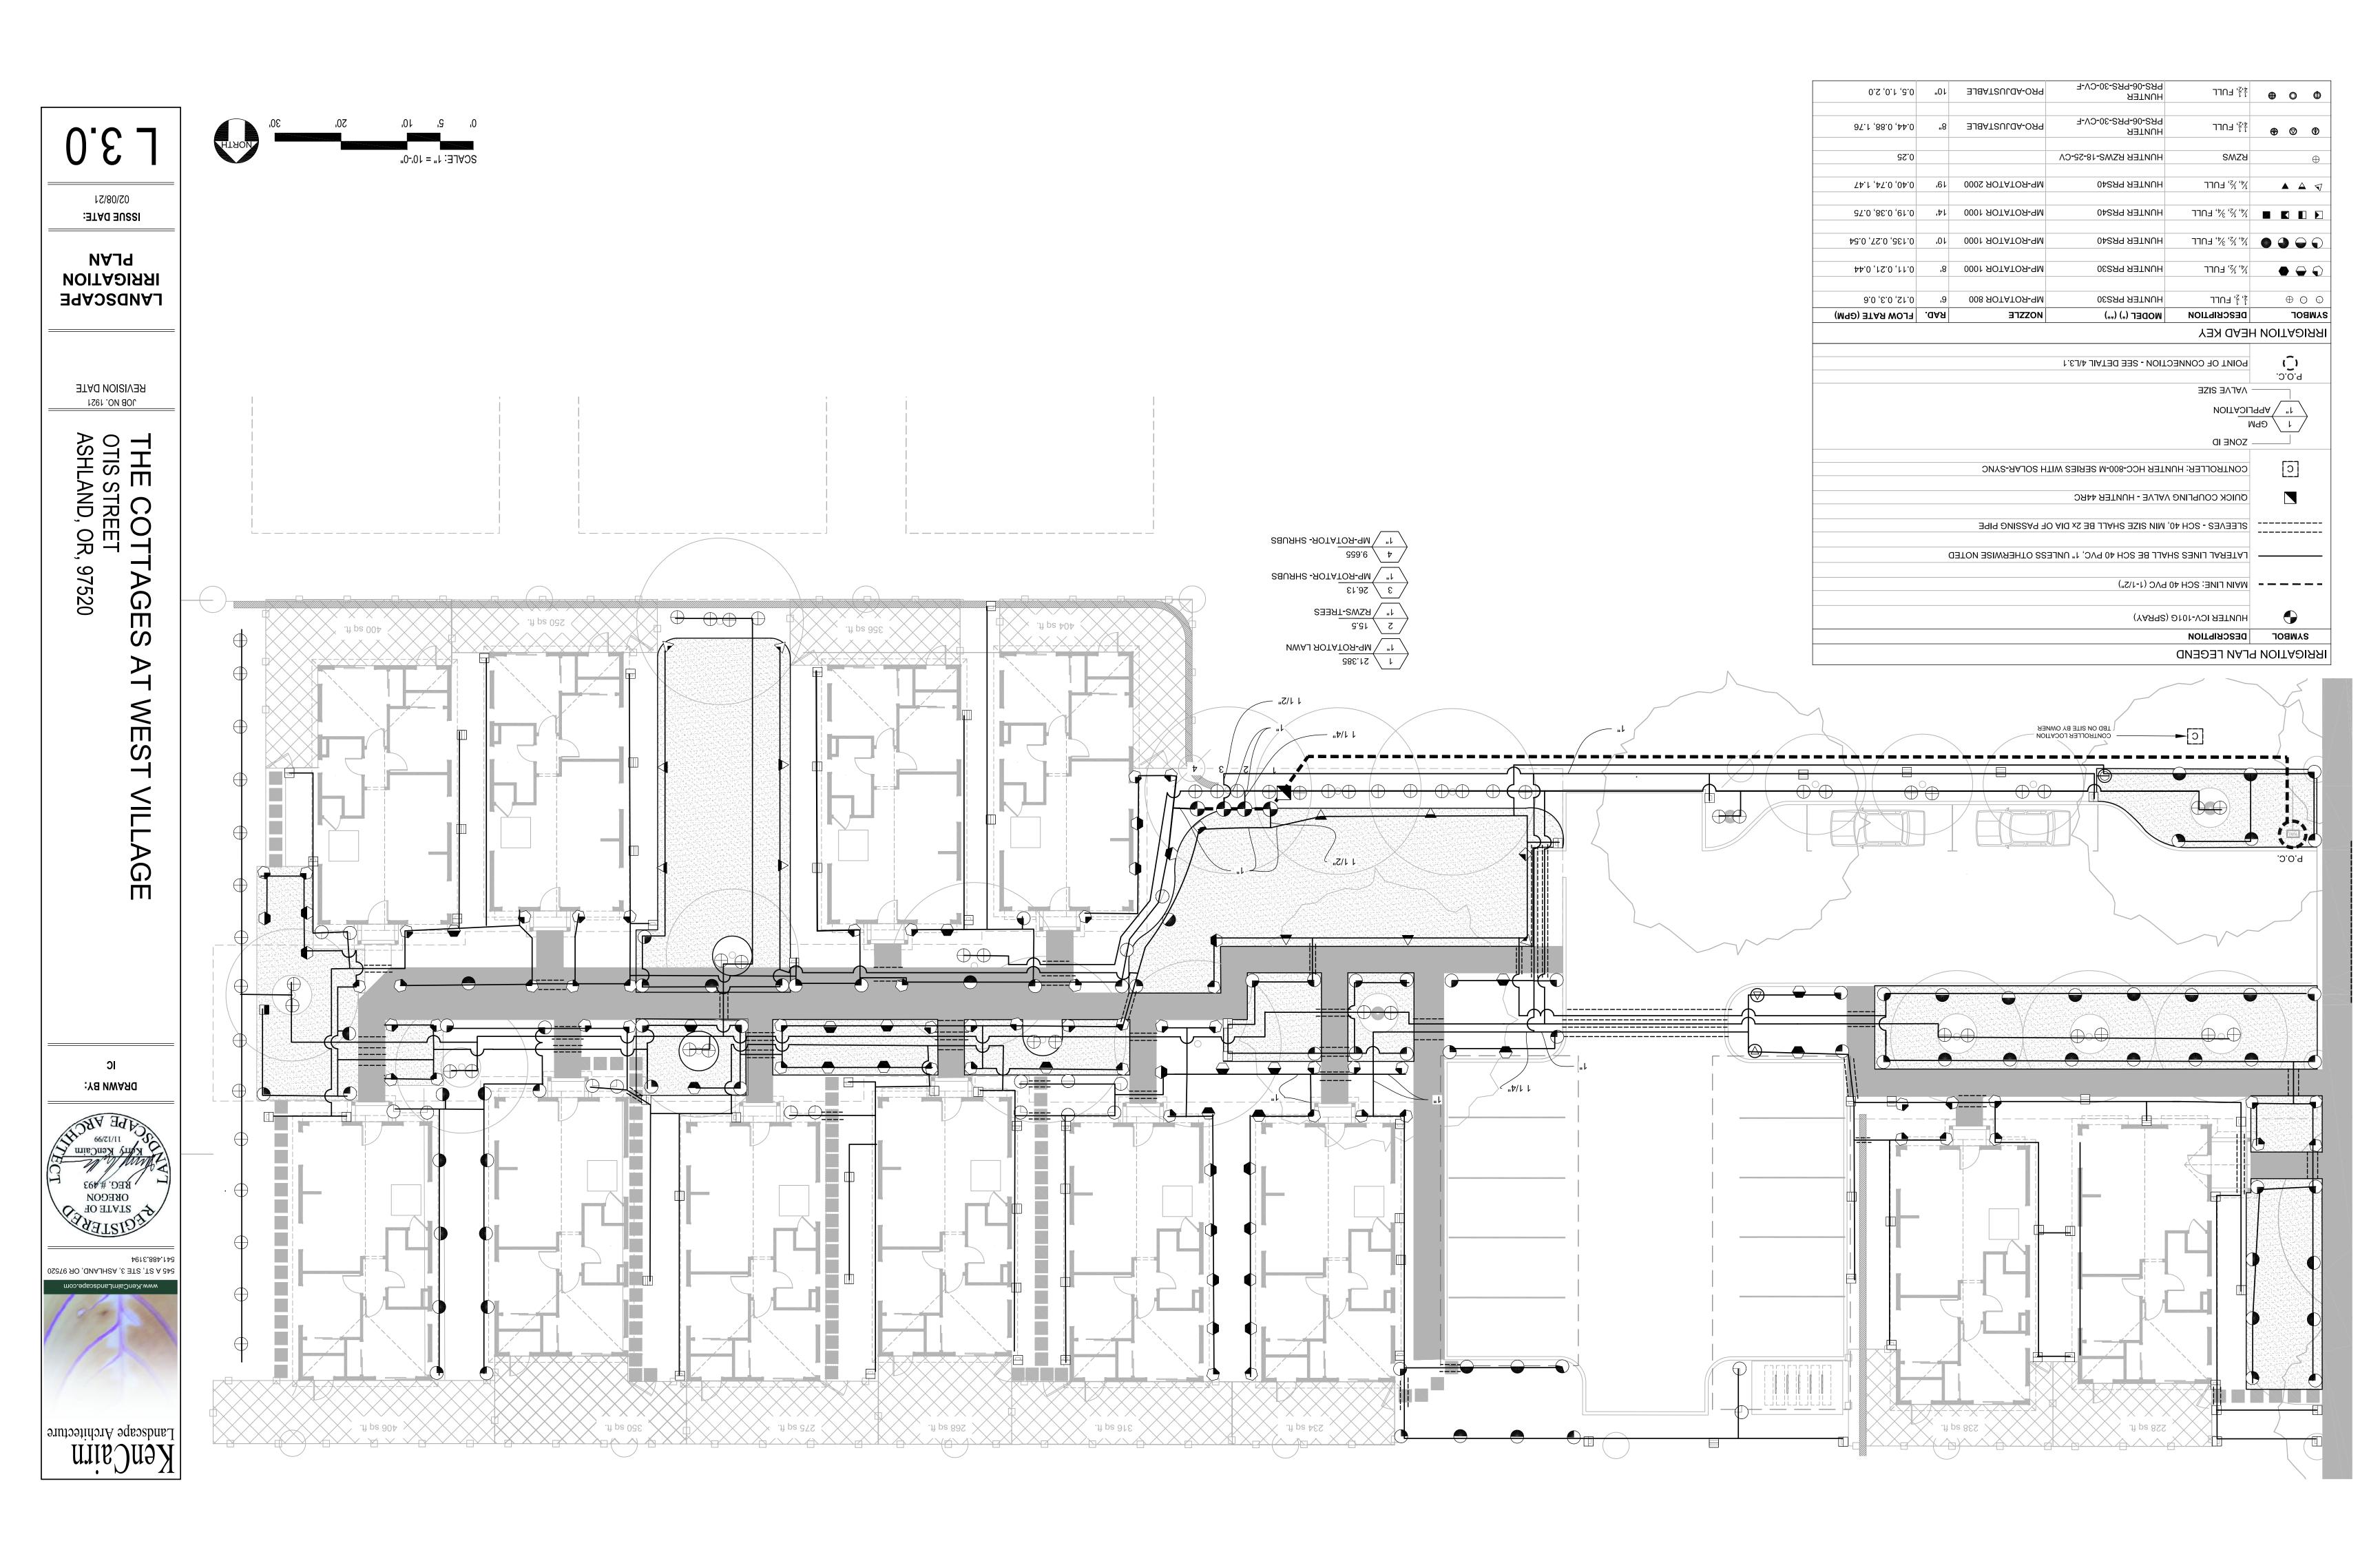

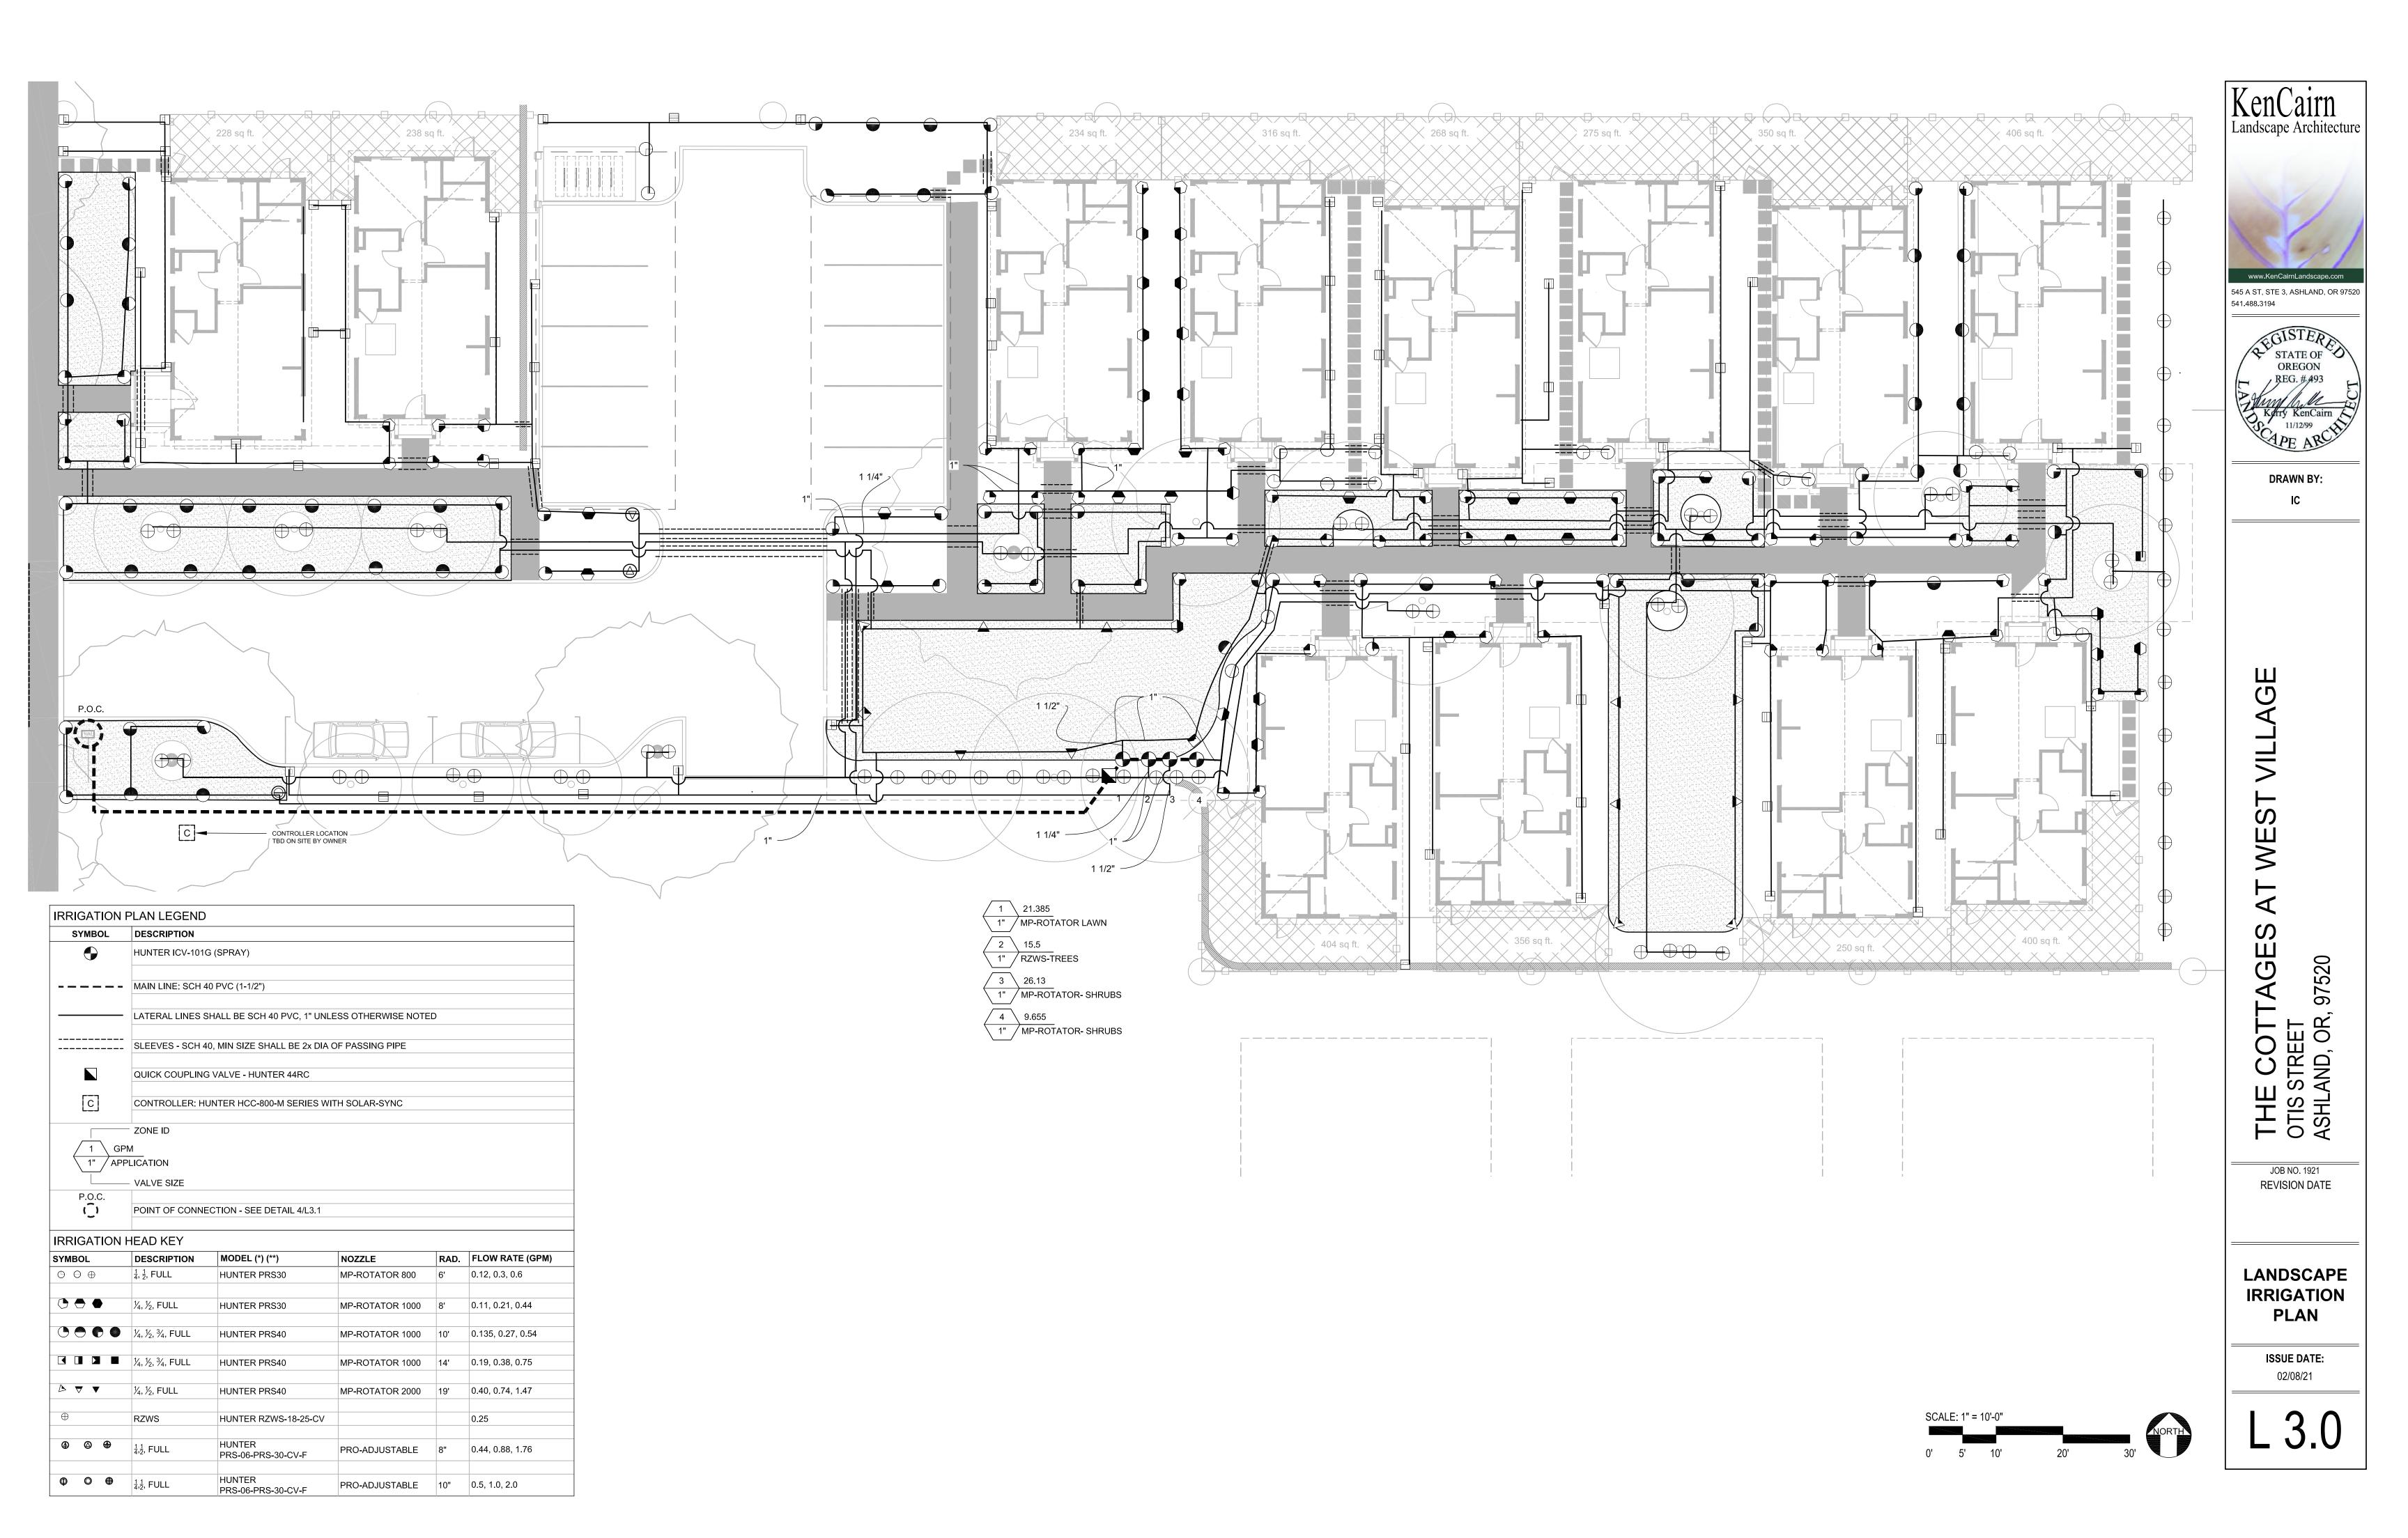

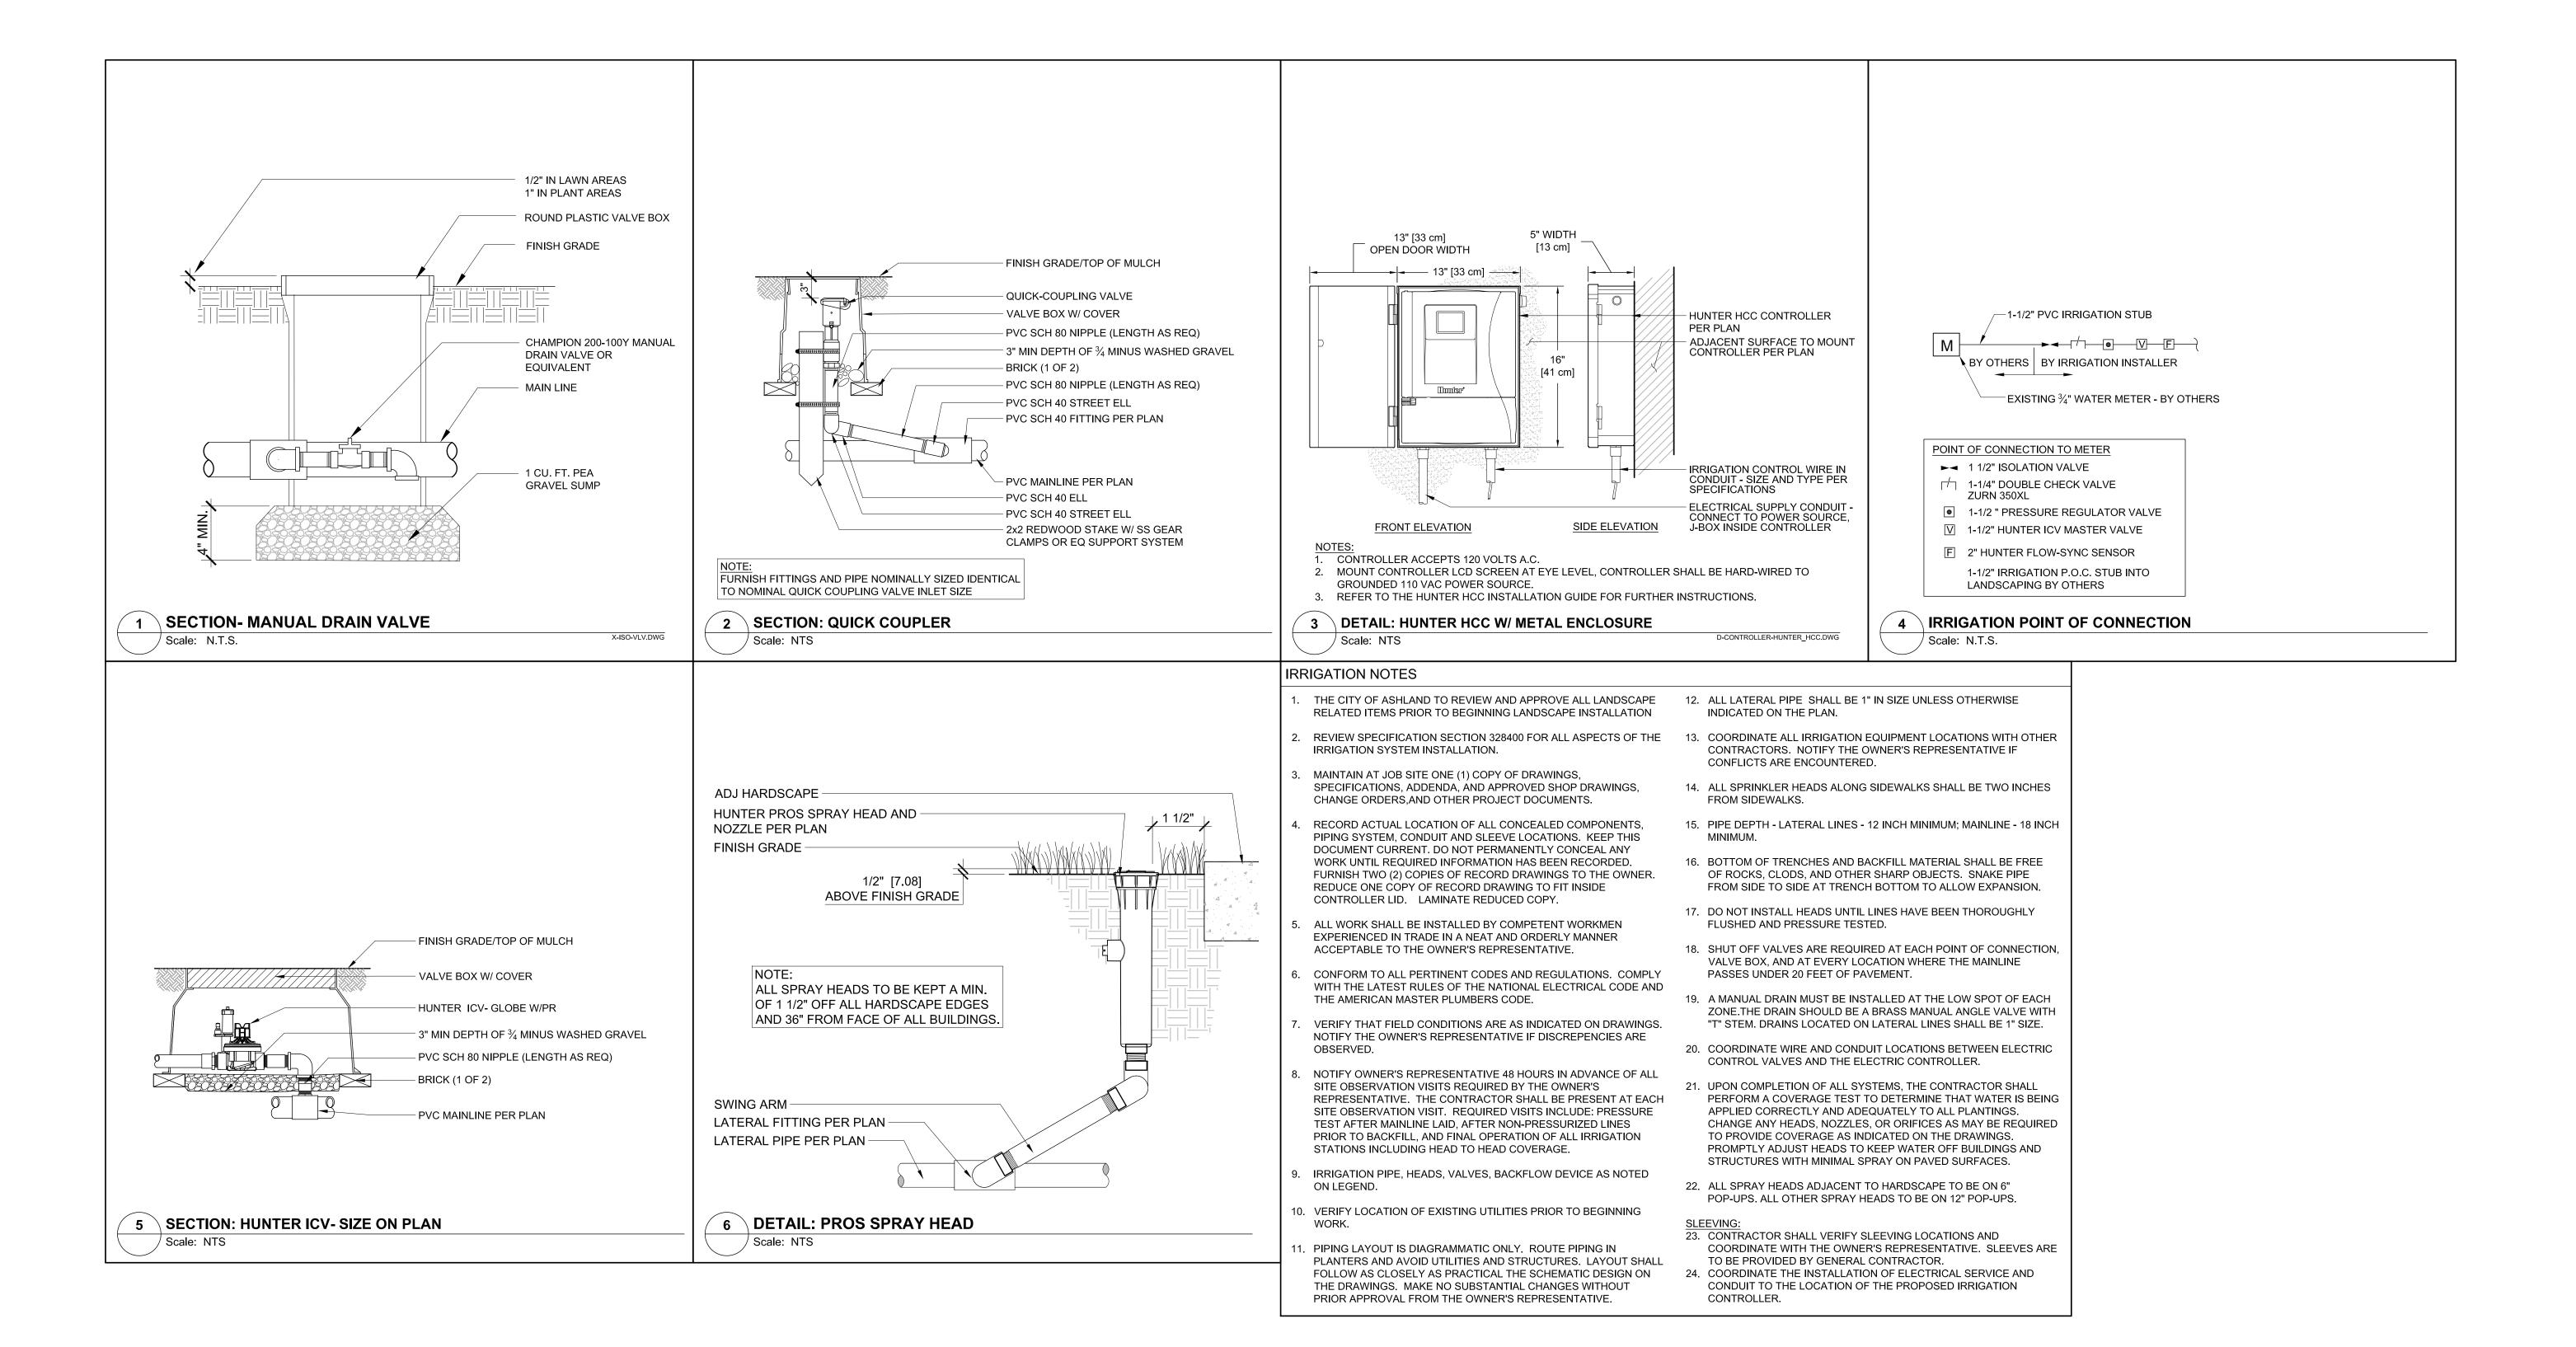

KenCairn
Landscape Architecture



541.488.3194




DRAWN BY:


5 THE OTIS S ASHLA


JOB NO. 1921 REVISION DATE

LANDSCAPE **IRRIGATION DETAILS**


> **ISSUE DATE:** 02/08/21

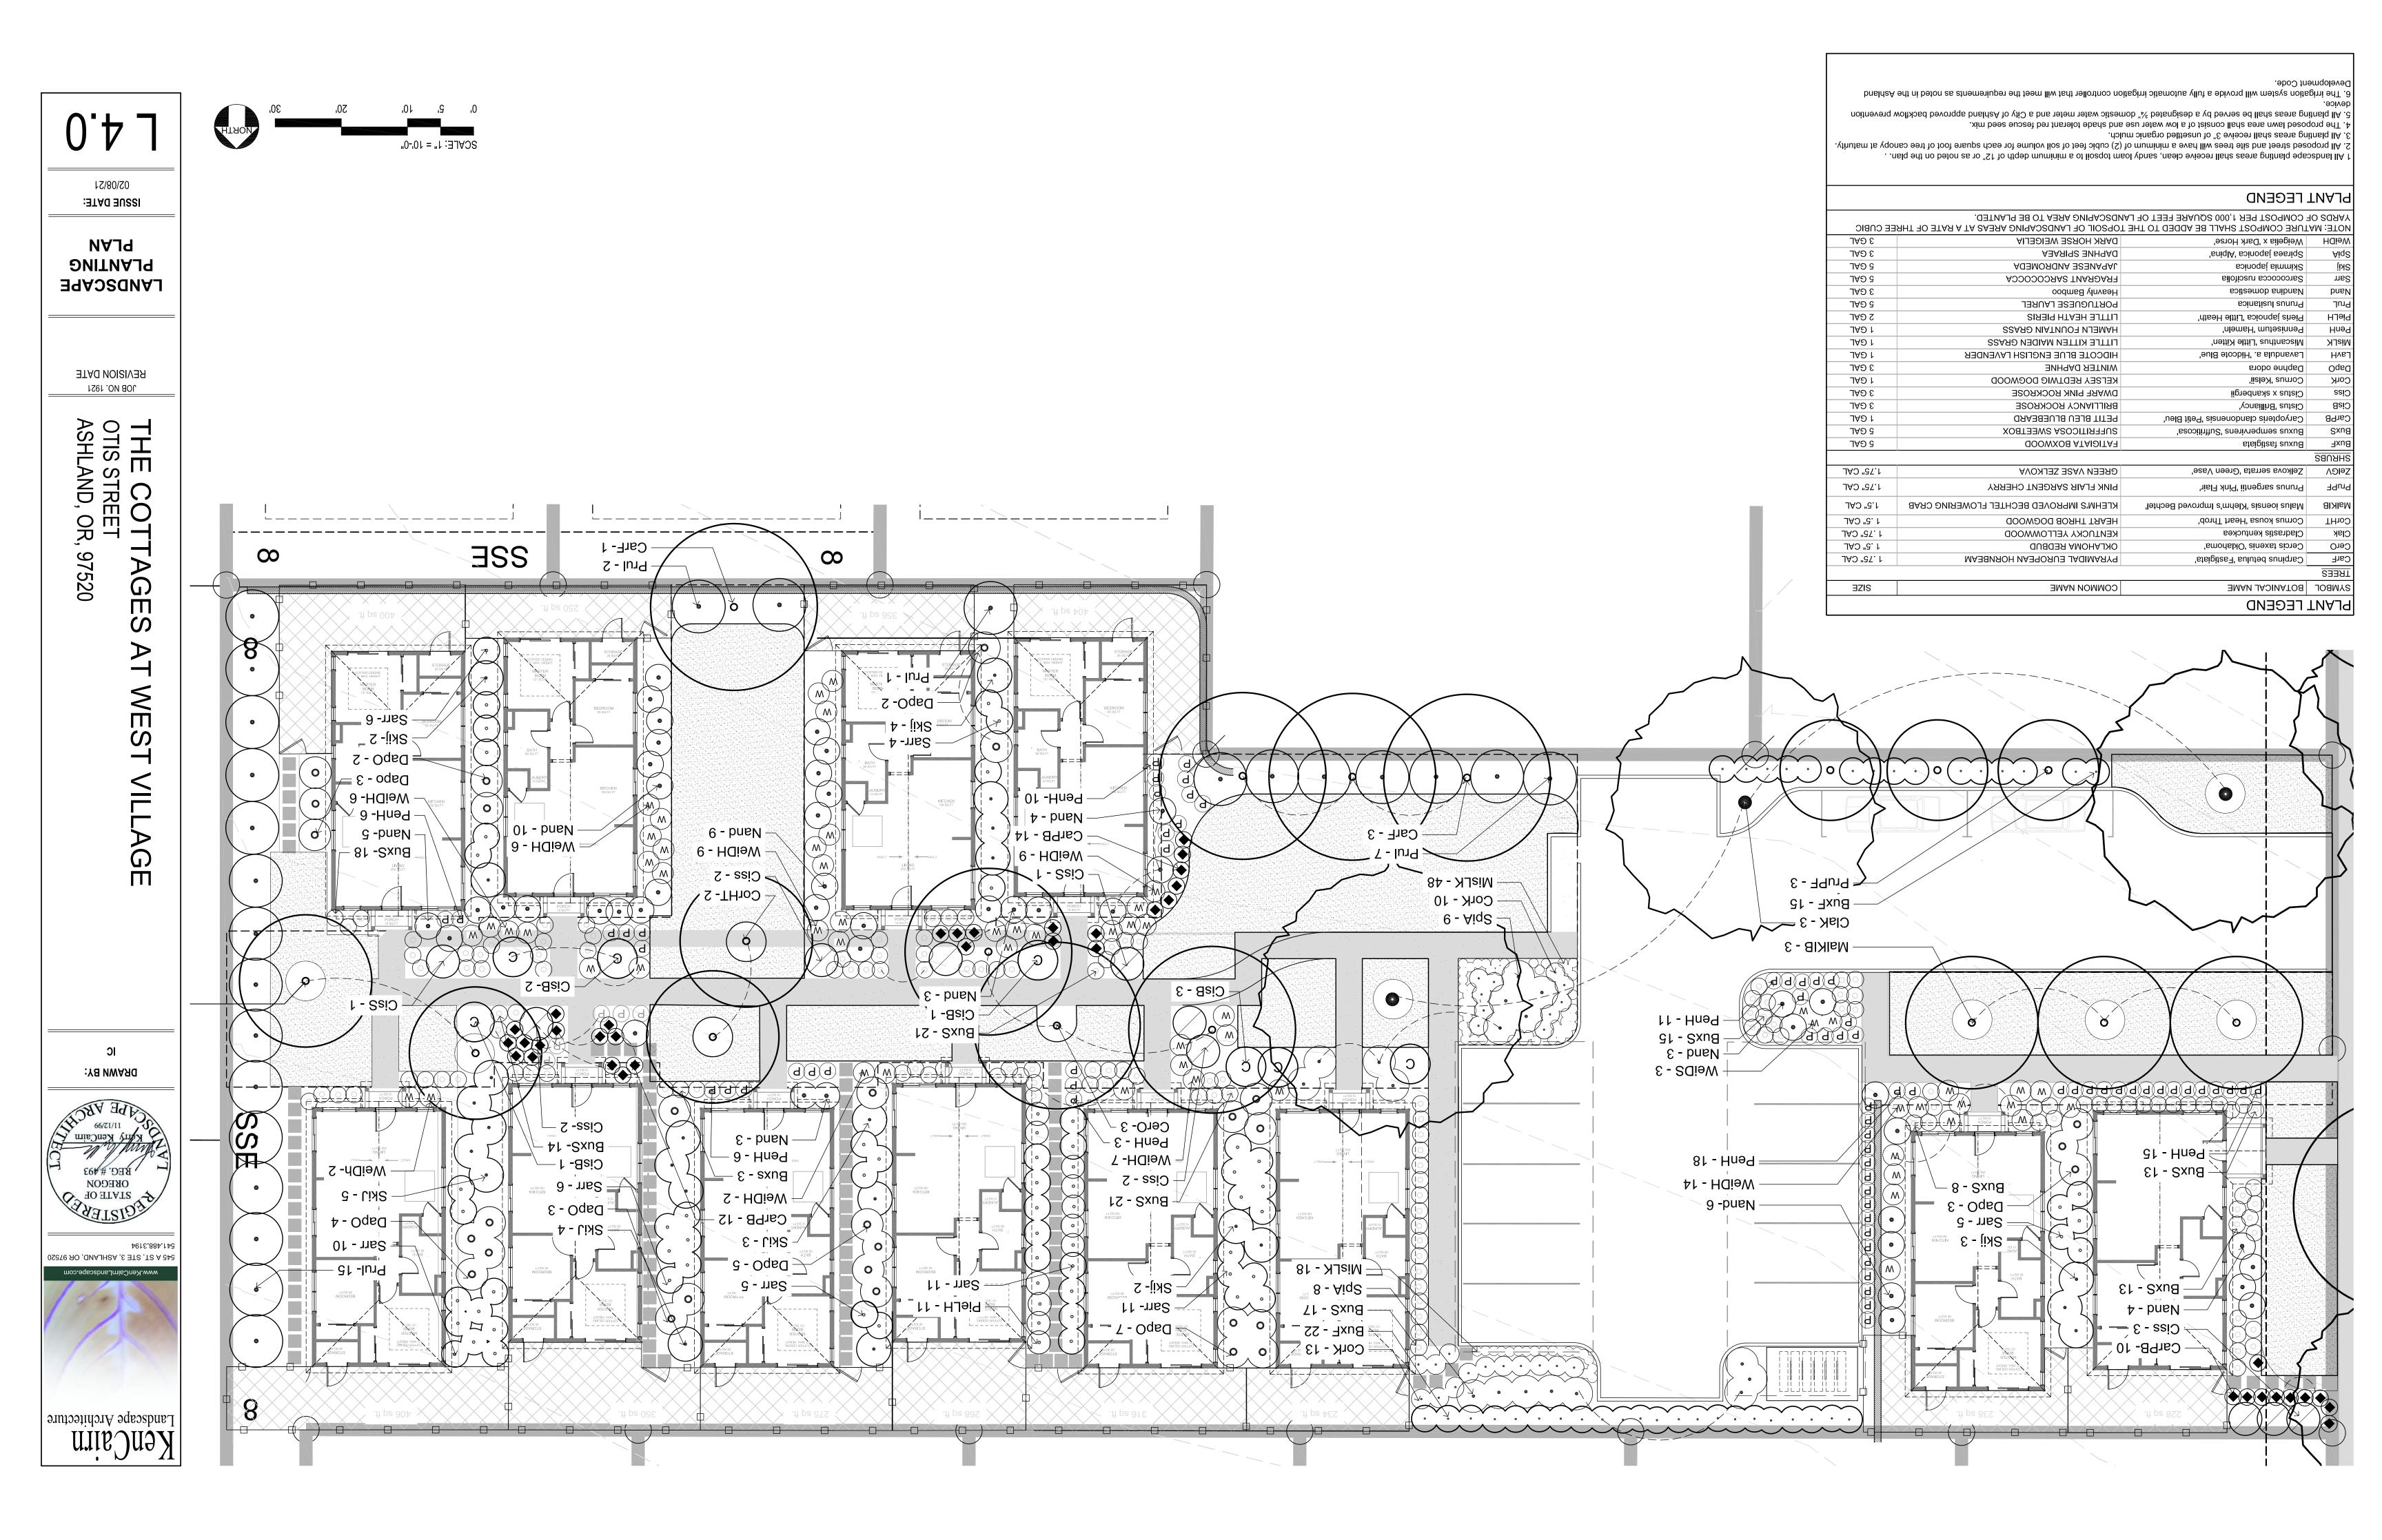


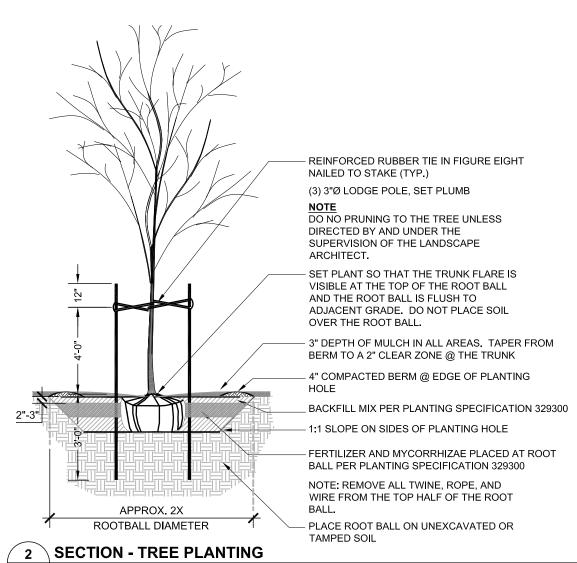


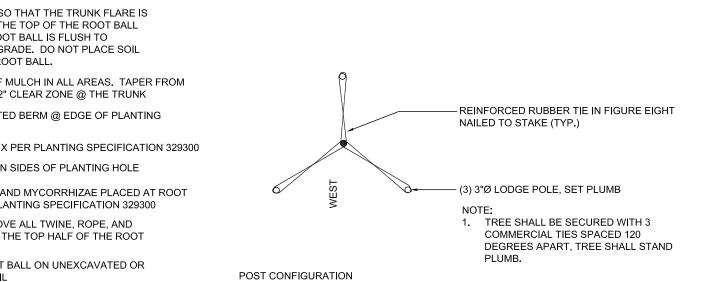

X-TREE-08.DWG

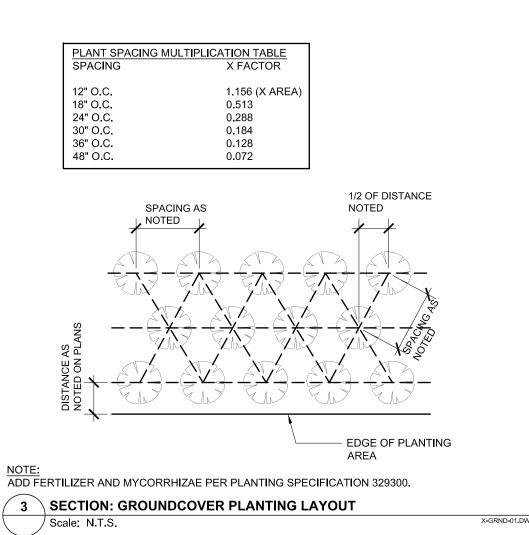

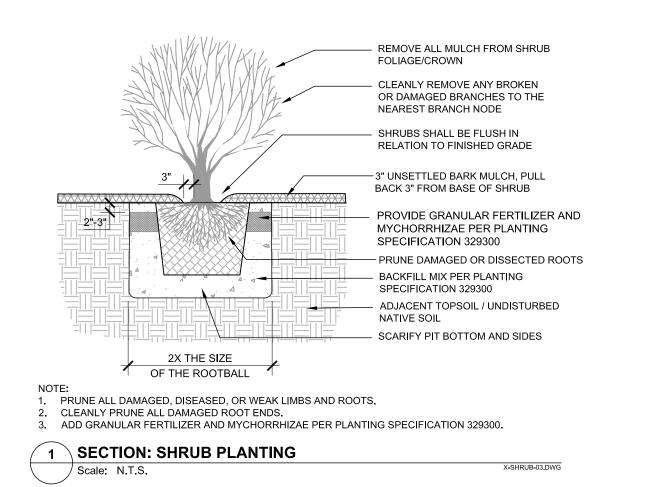

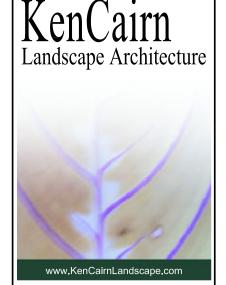

www.KenCairnLandscape.com 545 A ST, STE 3, ASHLAND, OR 97520 541.488.3194



DRAWN BY:

DIVAMMI

THE COTTAGES AT WEST VILLAGE OTIS STREET ASHLAND, OR, 97520

JOB NO. 1921 REVISION DATE

LANDSCAPE PLANTING DETAILS

ISSUE DATE: 02/08/21

L 4.1